PROJECT DIRECTORY

DEVELOPER/OWNER TOWN OF DAMASCUS 208 W LAUREL AVE. DAMASCUS, VA 24236 (276)783-5103 EXT. 315 CONTACT: MR. GAVIN N. BLEVINS, TOWN MANAGER

LANDSCAPE ARCHITECT DESTINATION BY DESIGN STUDIOS, PLLC 136 FURMAN RD. SUITE 6 BOONE, NC 28607 (828) 386-1866 CONTACT: MR. ALEX GOTHERMAN, PLA


STRUCTURAL ENGINEER IONCON, PLLC 726 STATE FARM RD. UNIT B BOONE, NC 28607 (828)264-8500 CONTACT: MR. PATRICK A. BEVILLE, PE LEED AP

STRUCTURAL ENGINEER ARETE' ENGINEERS, PLLC 7668 VALLEY BLVD. BLOWING ROCK, NC 28607 (828)434-0587 CONTACT: MR. BRIAN MULLIN, PE, CBSI

PROJECT MANAGER CONTACT: ALEX GOTHERMAN, PLA (828) 386-1866

SITE CONSTRUCTION DOCUMENTS FOR: Laurel Creek Park & Trail

208 W LAUREL AVE. DAMASCUS, VA 24236

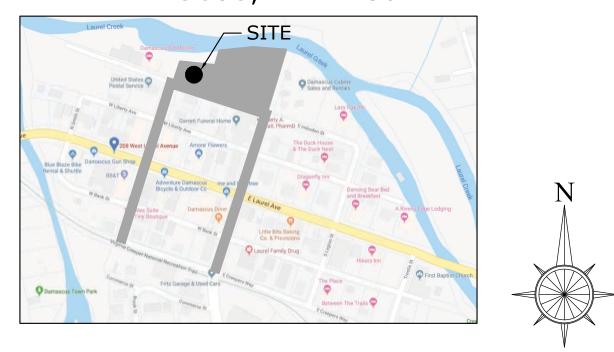

VICINITY MAP NOT TO SCALE

PREPARED BY: DESTINATION BY DESIGN STUDIOS, PLLC


136 FURMAN RD., SUITE 6 **BOONE, NC 28607** (828)386-1866 NOVEMBER 22, 2019 9.26.16

Q)	


SHEE	T INDEX
COV	COVER SHEET
SH-1	SURVEY SHEET 1
SH-2	SURVEY SHEET 2
SH-3	SURVEY SHEET 3
SH-4	SURVEY SHEET 4
SH-5	SURVEY SHEET 5
C-1	SITE PLAN-OVERVIEW
C-1.1	SITE PLAN-SHADY AVE.
C-1.2	SITE PLAN-LAUREL CREEK PARK
C-1.3	SITE PLAN-REYNOLDS ST.
C-1.4	SITE PLAN-COMPASS ENLARGEMENT
C-2	NOTES & CONSTRUCTION DETAILS
C-2.1	NOTES & CONSTRUCTION DETAILS
C-2.2	NOTES & CONSTRUCTION DETAILS
C-2.3	NOTES & CONSTRUCTION DETAILS
C-2.4	NOTES & CONSTRUCTION DETAILS
C-3	PAVING, GRADING, & DRAINAGE PLAN
G-1	PAVILION SIGN
G-2	WAYFINDING GATEWAY
G-3.1	WAYFINDING SIGNAGE
G-3.2	WAYFINDING DESTINATION PANELS
L-1	LANDSCAPE PLAN
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L-2	LANDSCAPE PLAN
L-2	LANDSCAPE PLAN
L-6	LANDSCAPE NOTES & DETAILS
PAVILI	ON
COV	COVER SHEET
G01	MAIN FLOOR PLAN
G03	
	CONNECTION DETAILS
E01	LIGHTING/ELECTRICAL PLAN
STAGE	
COV	COVER SHEET
G01	PLANS
G02	ELEVATIONS
S01	CONNECTION DETAILS
BATHR	
	COVER SHEET
$(\neg ())$	MAIN FLOOR + ELECTRICAL + PLUMBING PLAN

- MAIN FLOOR + ELECTRICAL + PLUMBING PLANS G01
- G02 ELEVATIONS
- SITE/ELECTRICAL PLAN E-1

	REVISIONS:		
NO.	DESCRIPTION:	BY:	DATE:
1	WASHINGTON COUNTY E&S	DAD	10/02/19
2	VDOT	DAD	10/03/19

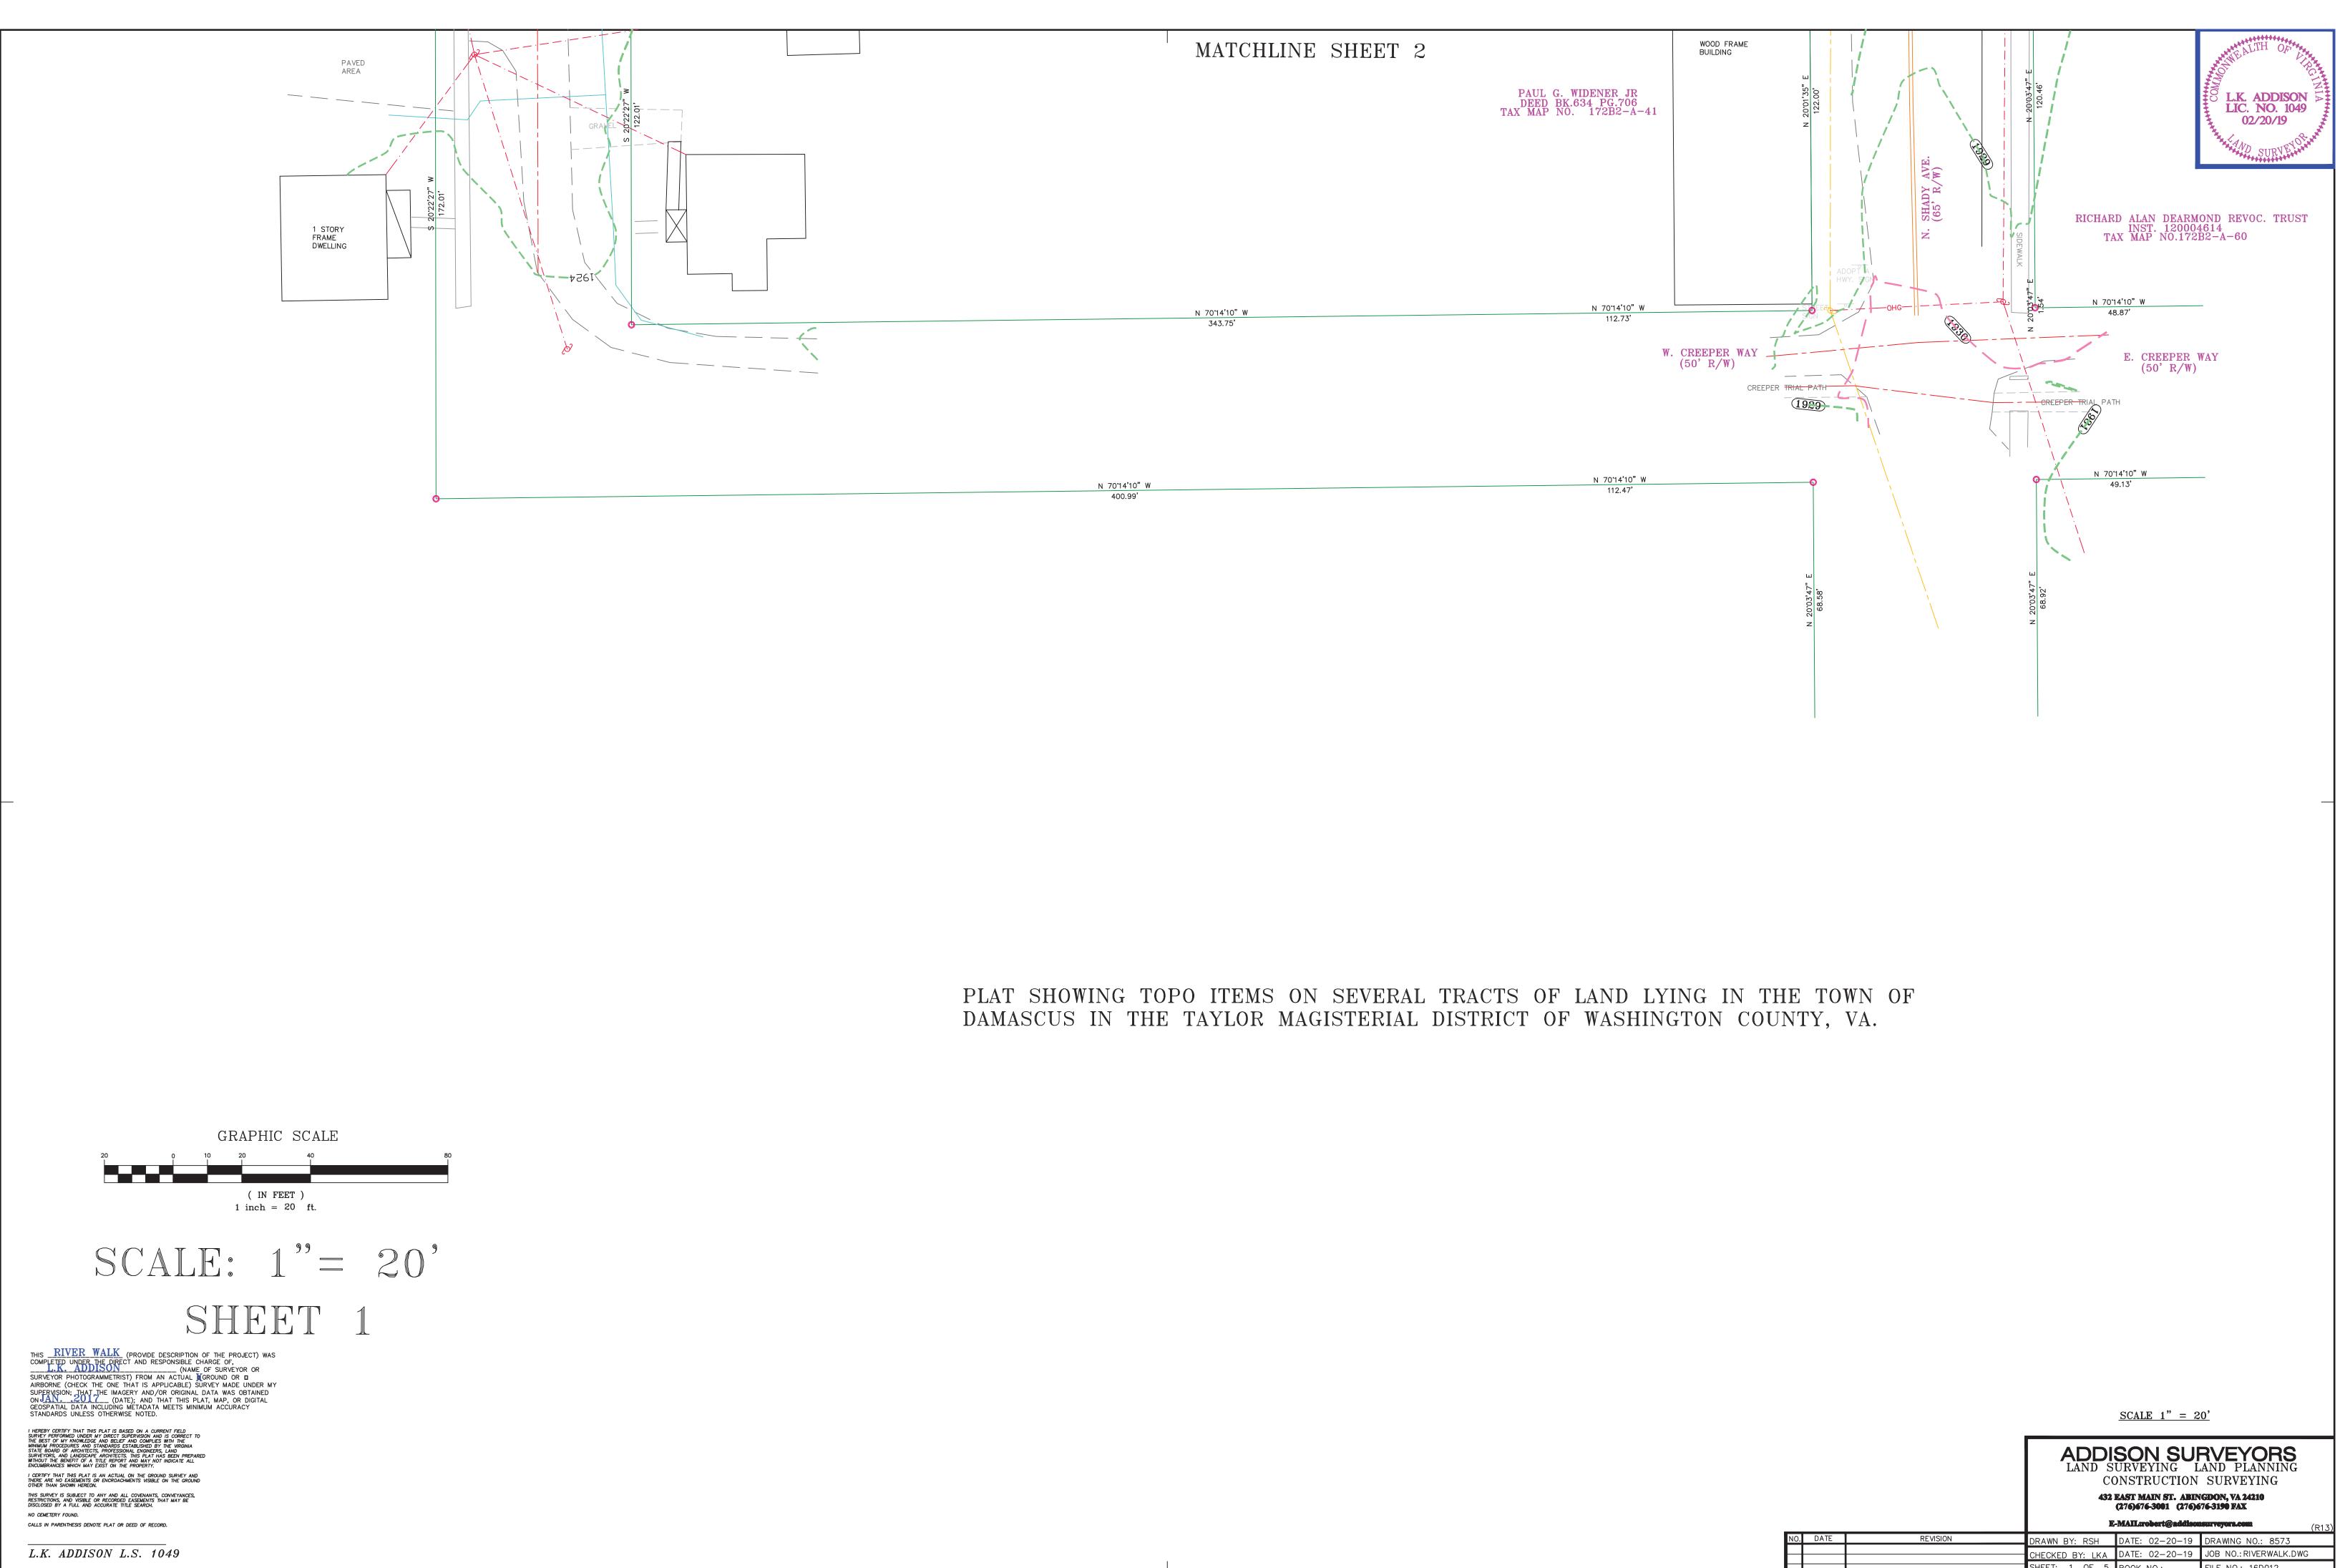



			432 EAST MAIN ST. ABINGDON, VA 24210 (276)676-3001 (276)676-3190 FAX			
		IC	-MAIL:robert@addisou	Isurveyors.com (R [*]	:13)	
١٥.	DATE	REVISION	DRAWN BY: RSH	DATE: 02-20-19	DRAWING NO.: 8573	
\rightarrow			CHECKED BY: LKA	DATE: 02-20-19	JOB NO .: RIVERWALK.DWG	
			SHEET: 1 OF 5	BOOK NO.:	FILE NO.: 16D012	

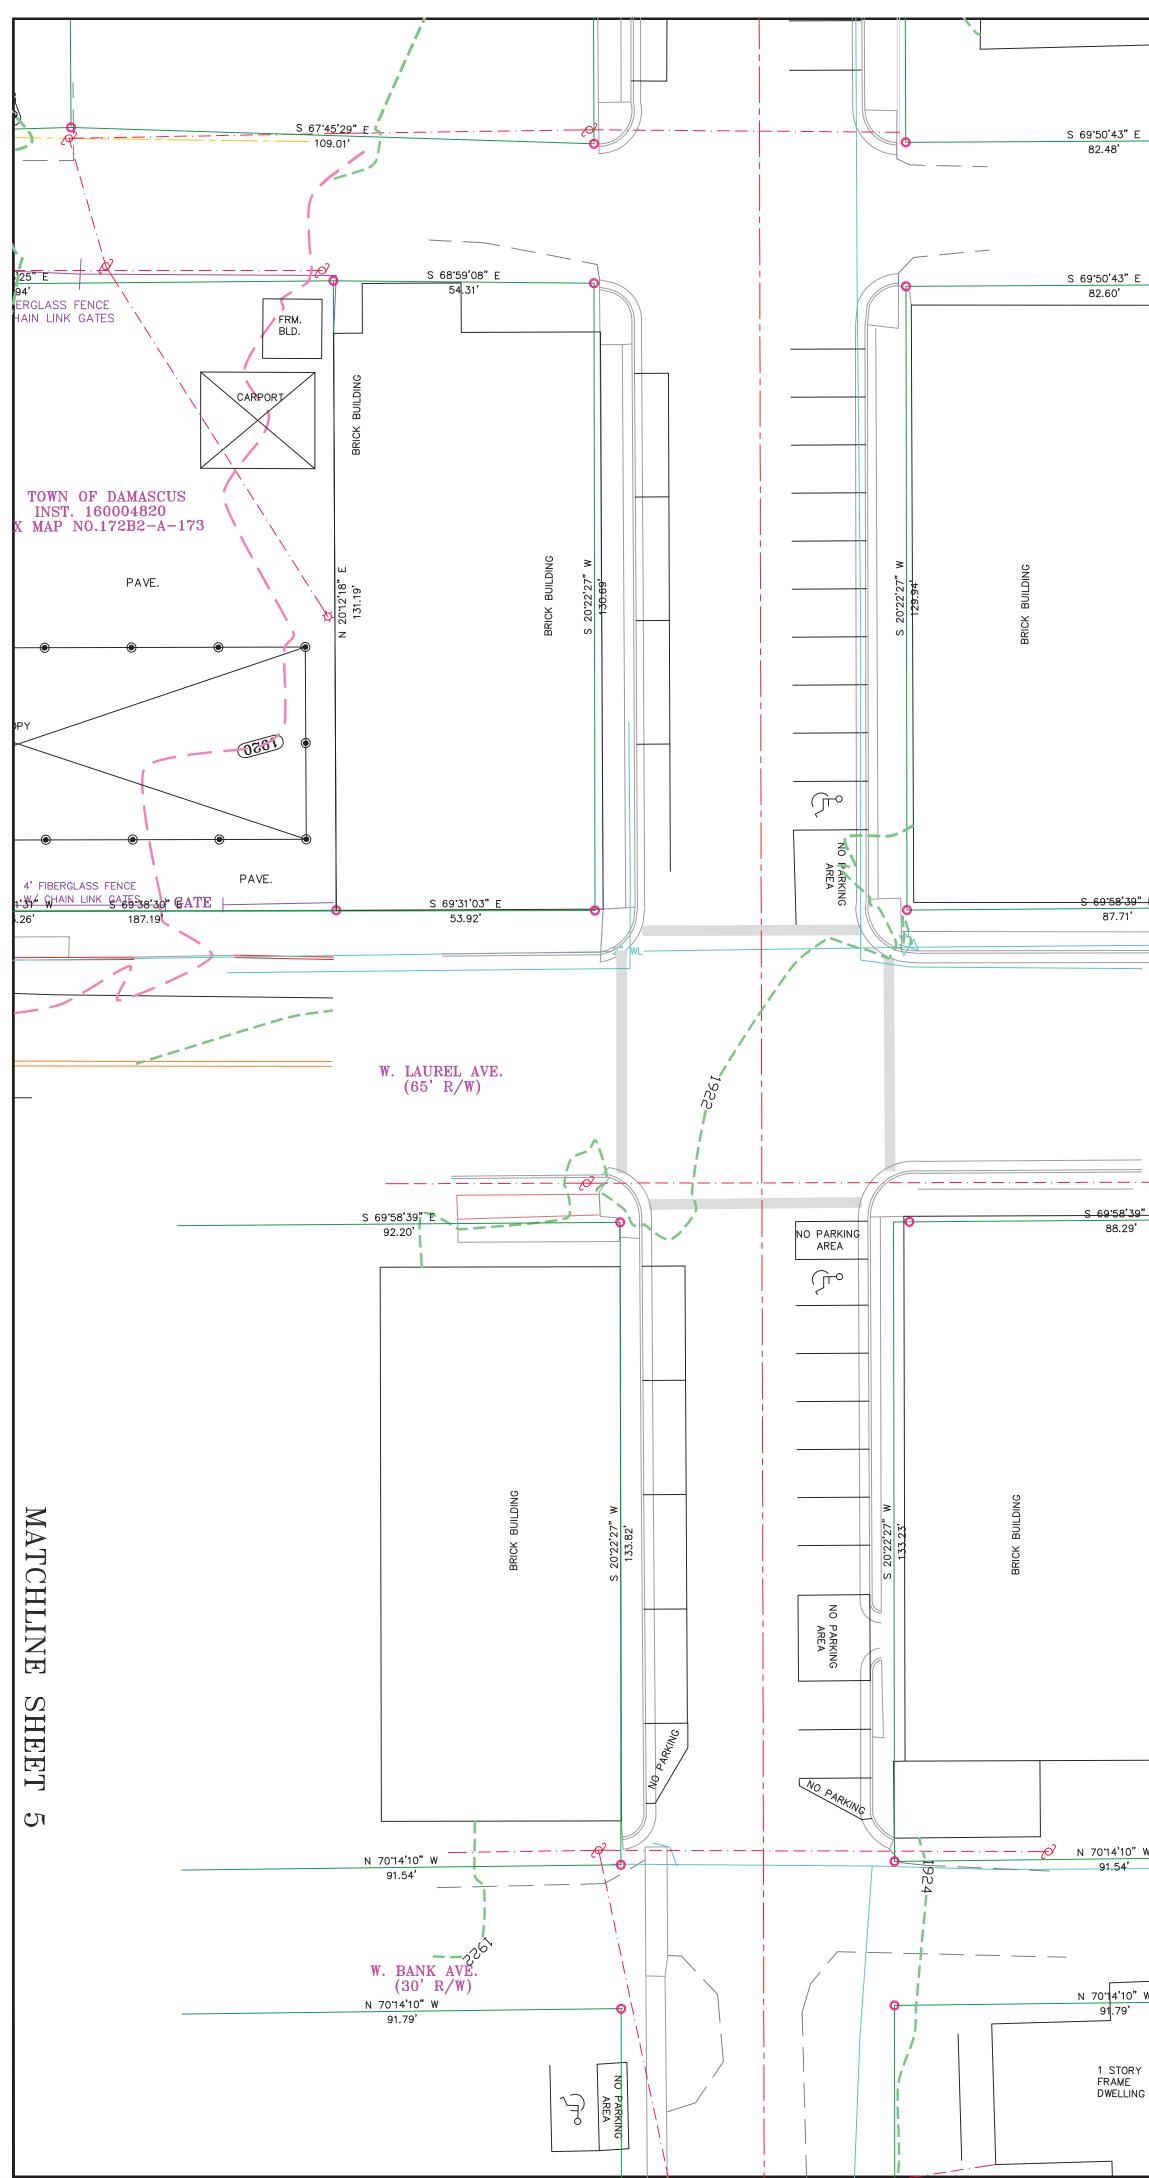


	_				122.85' W. LIBERTY AVE. (30' R/W)
" E	_				S 70'33'39" E 122.85'
					T
1 <mark>39" E</mark> 11'					S 69'58'39" E 118.44'
					W. LAUREL AVE. (65' R/W)
<u>с</u> - <u></u>]				<u>S 69'58'39" E</u> 118.48'
					D TAX
					EARL C. KILLIAN INST. 13000144' TAX MAP NO.172B2-
0" W 4'					<u>N 70'14'10" W</u> 113.42' W. BANK AVE.
					W. BANK AVE. (30' R/W)
IO" W					<u>N 70°14'10" W</u> 113.29'
DRY IE LING					
		МАТС	CHLINE SHE	ET 1	


S 70°33'39" E

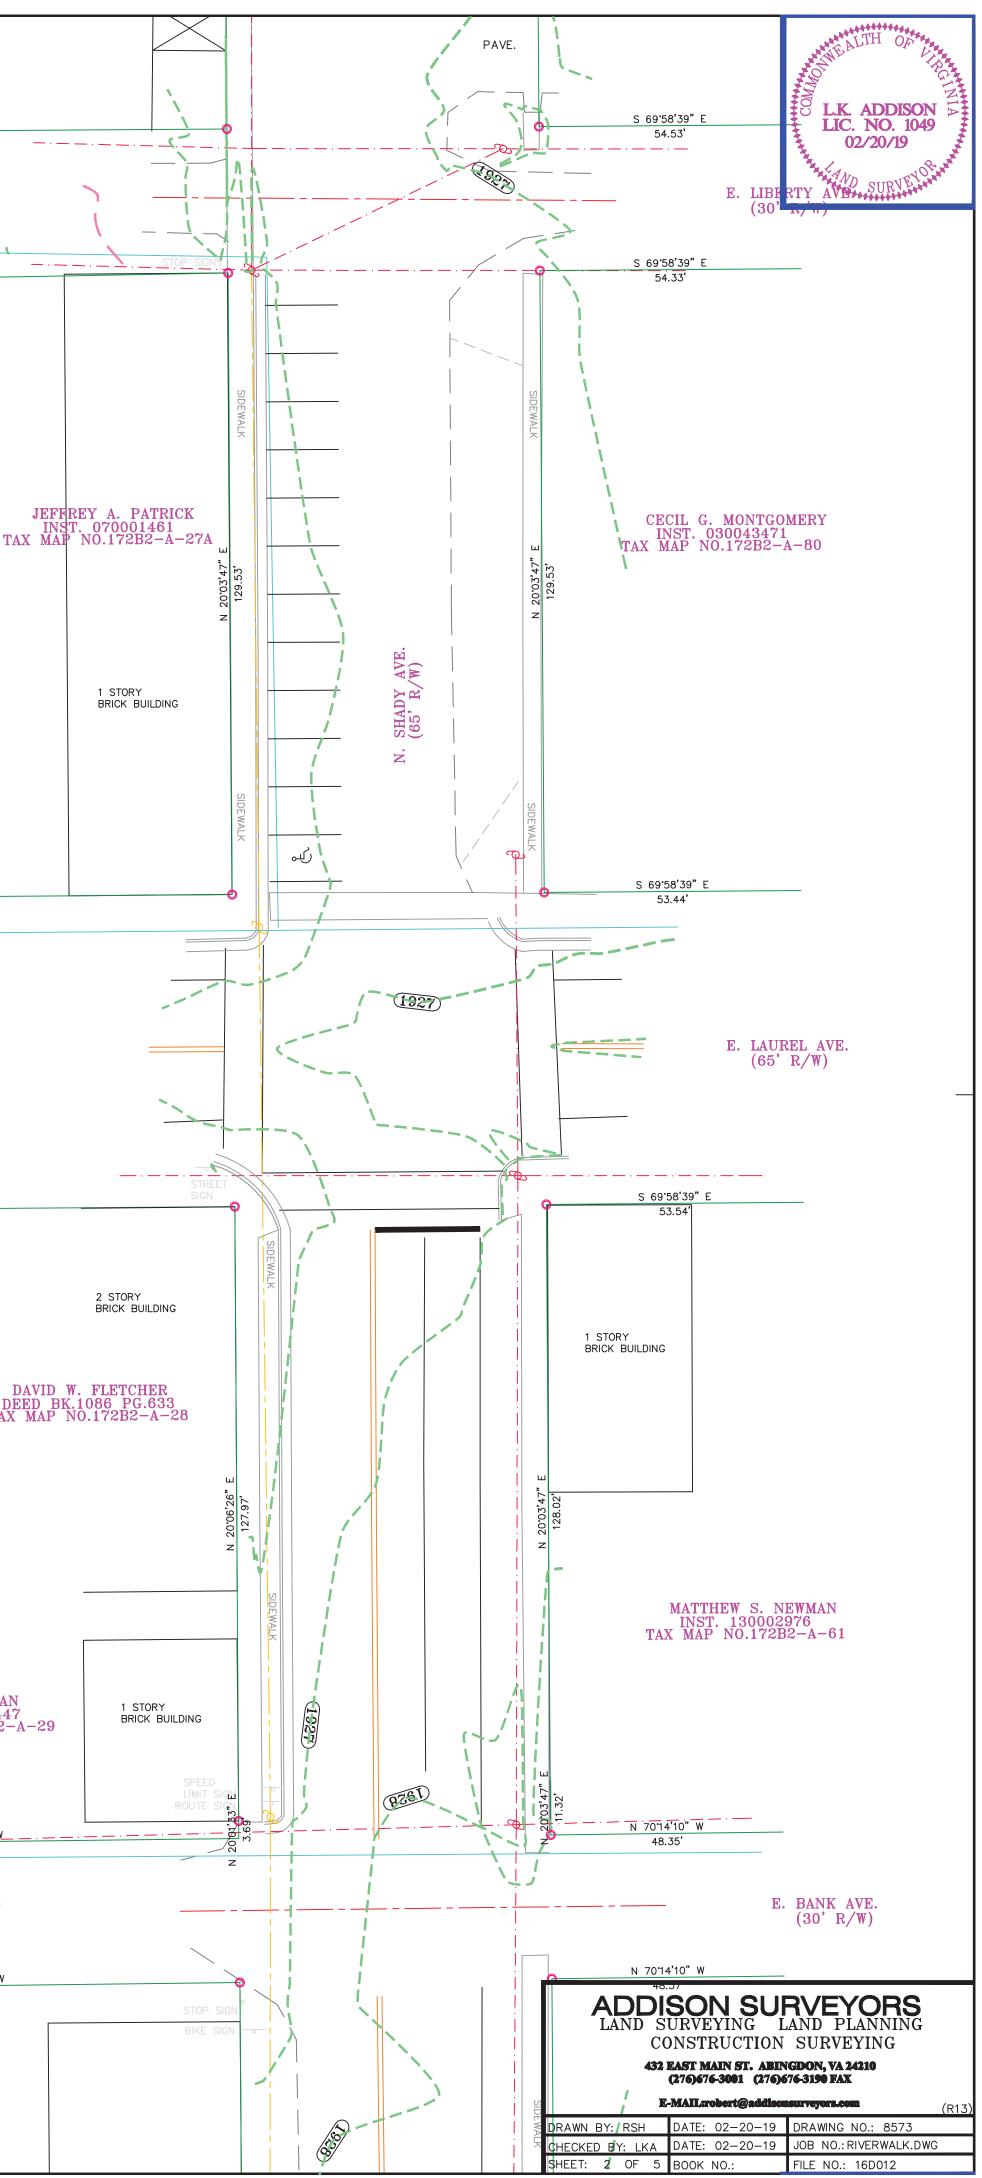


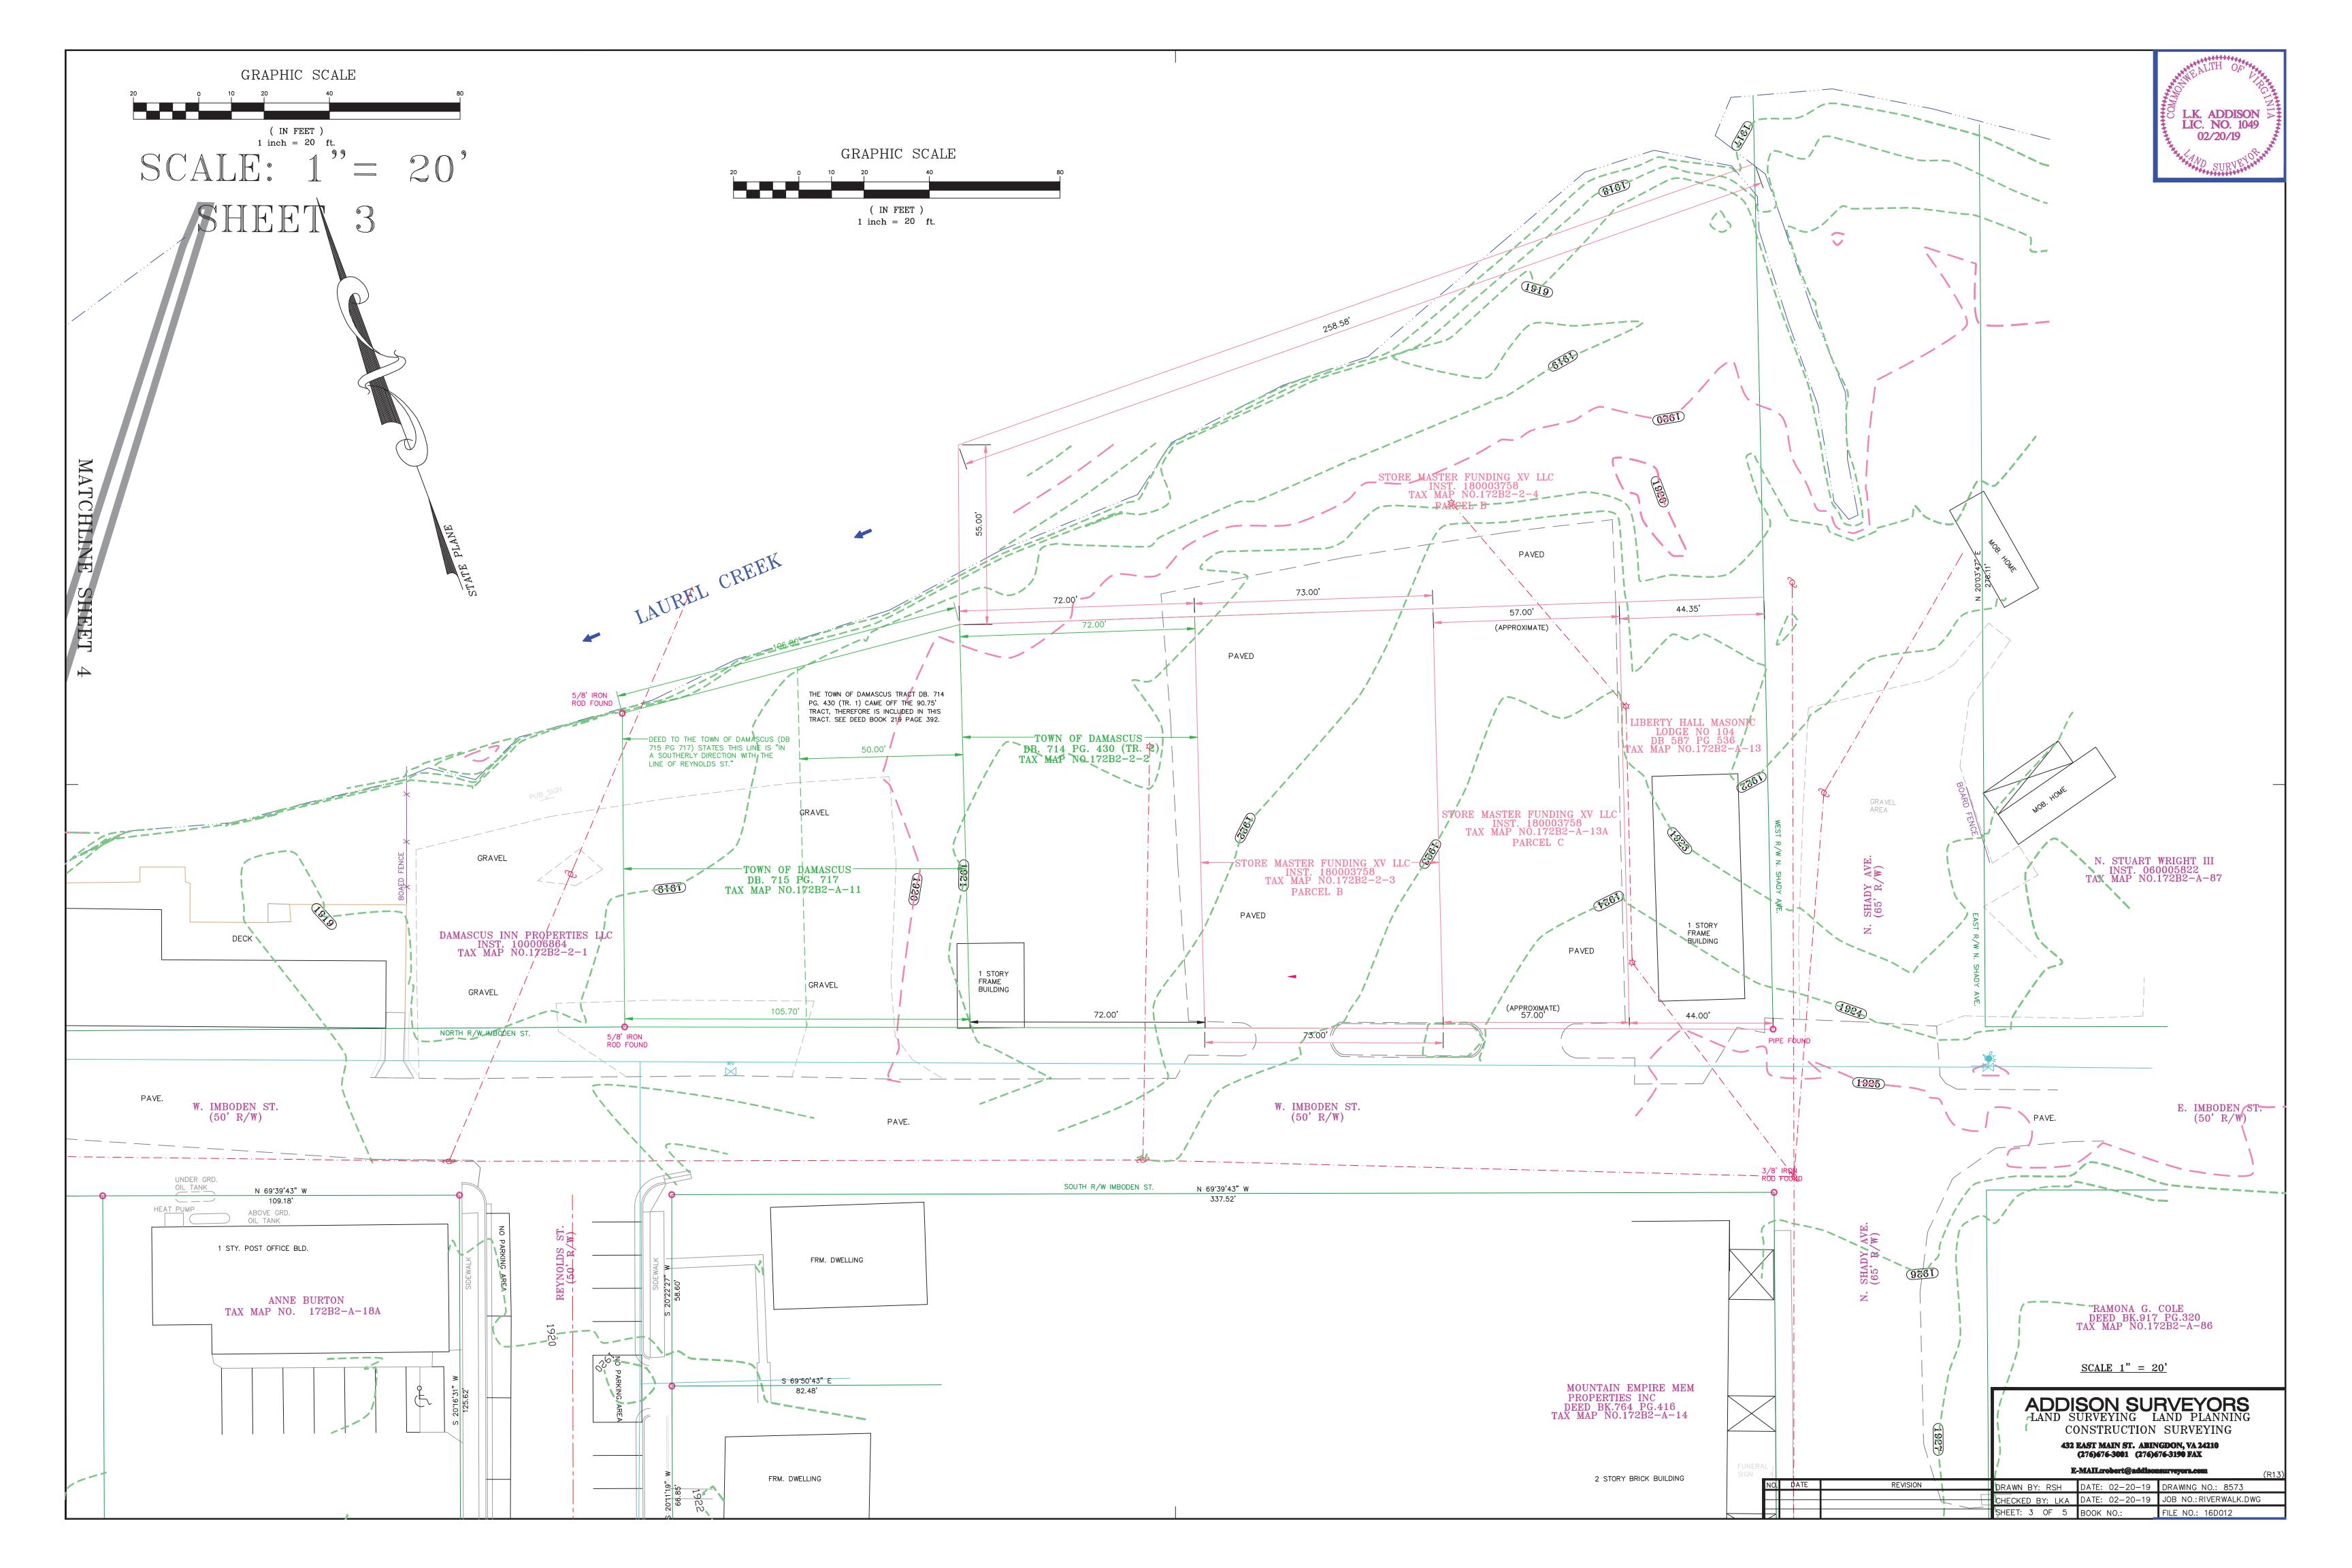


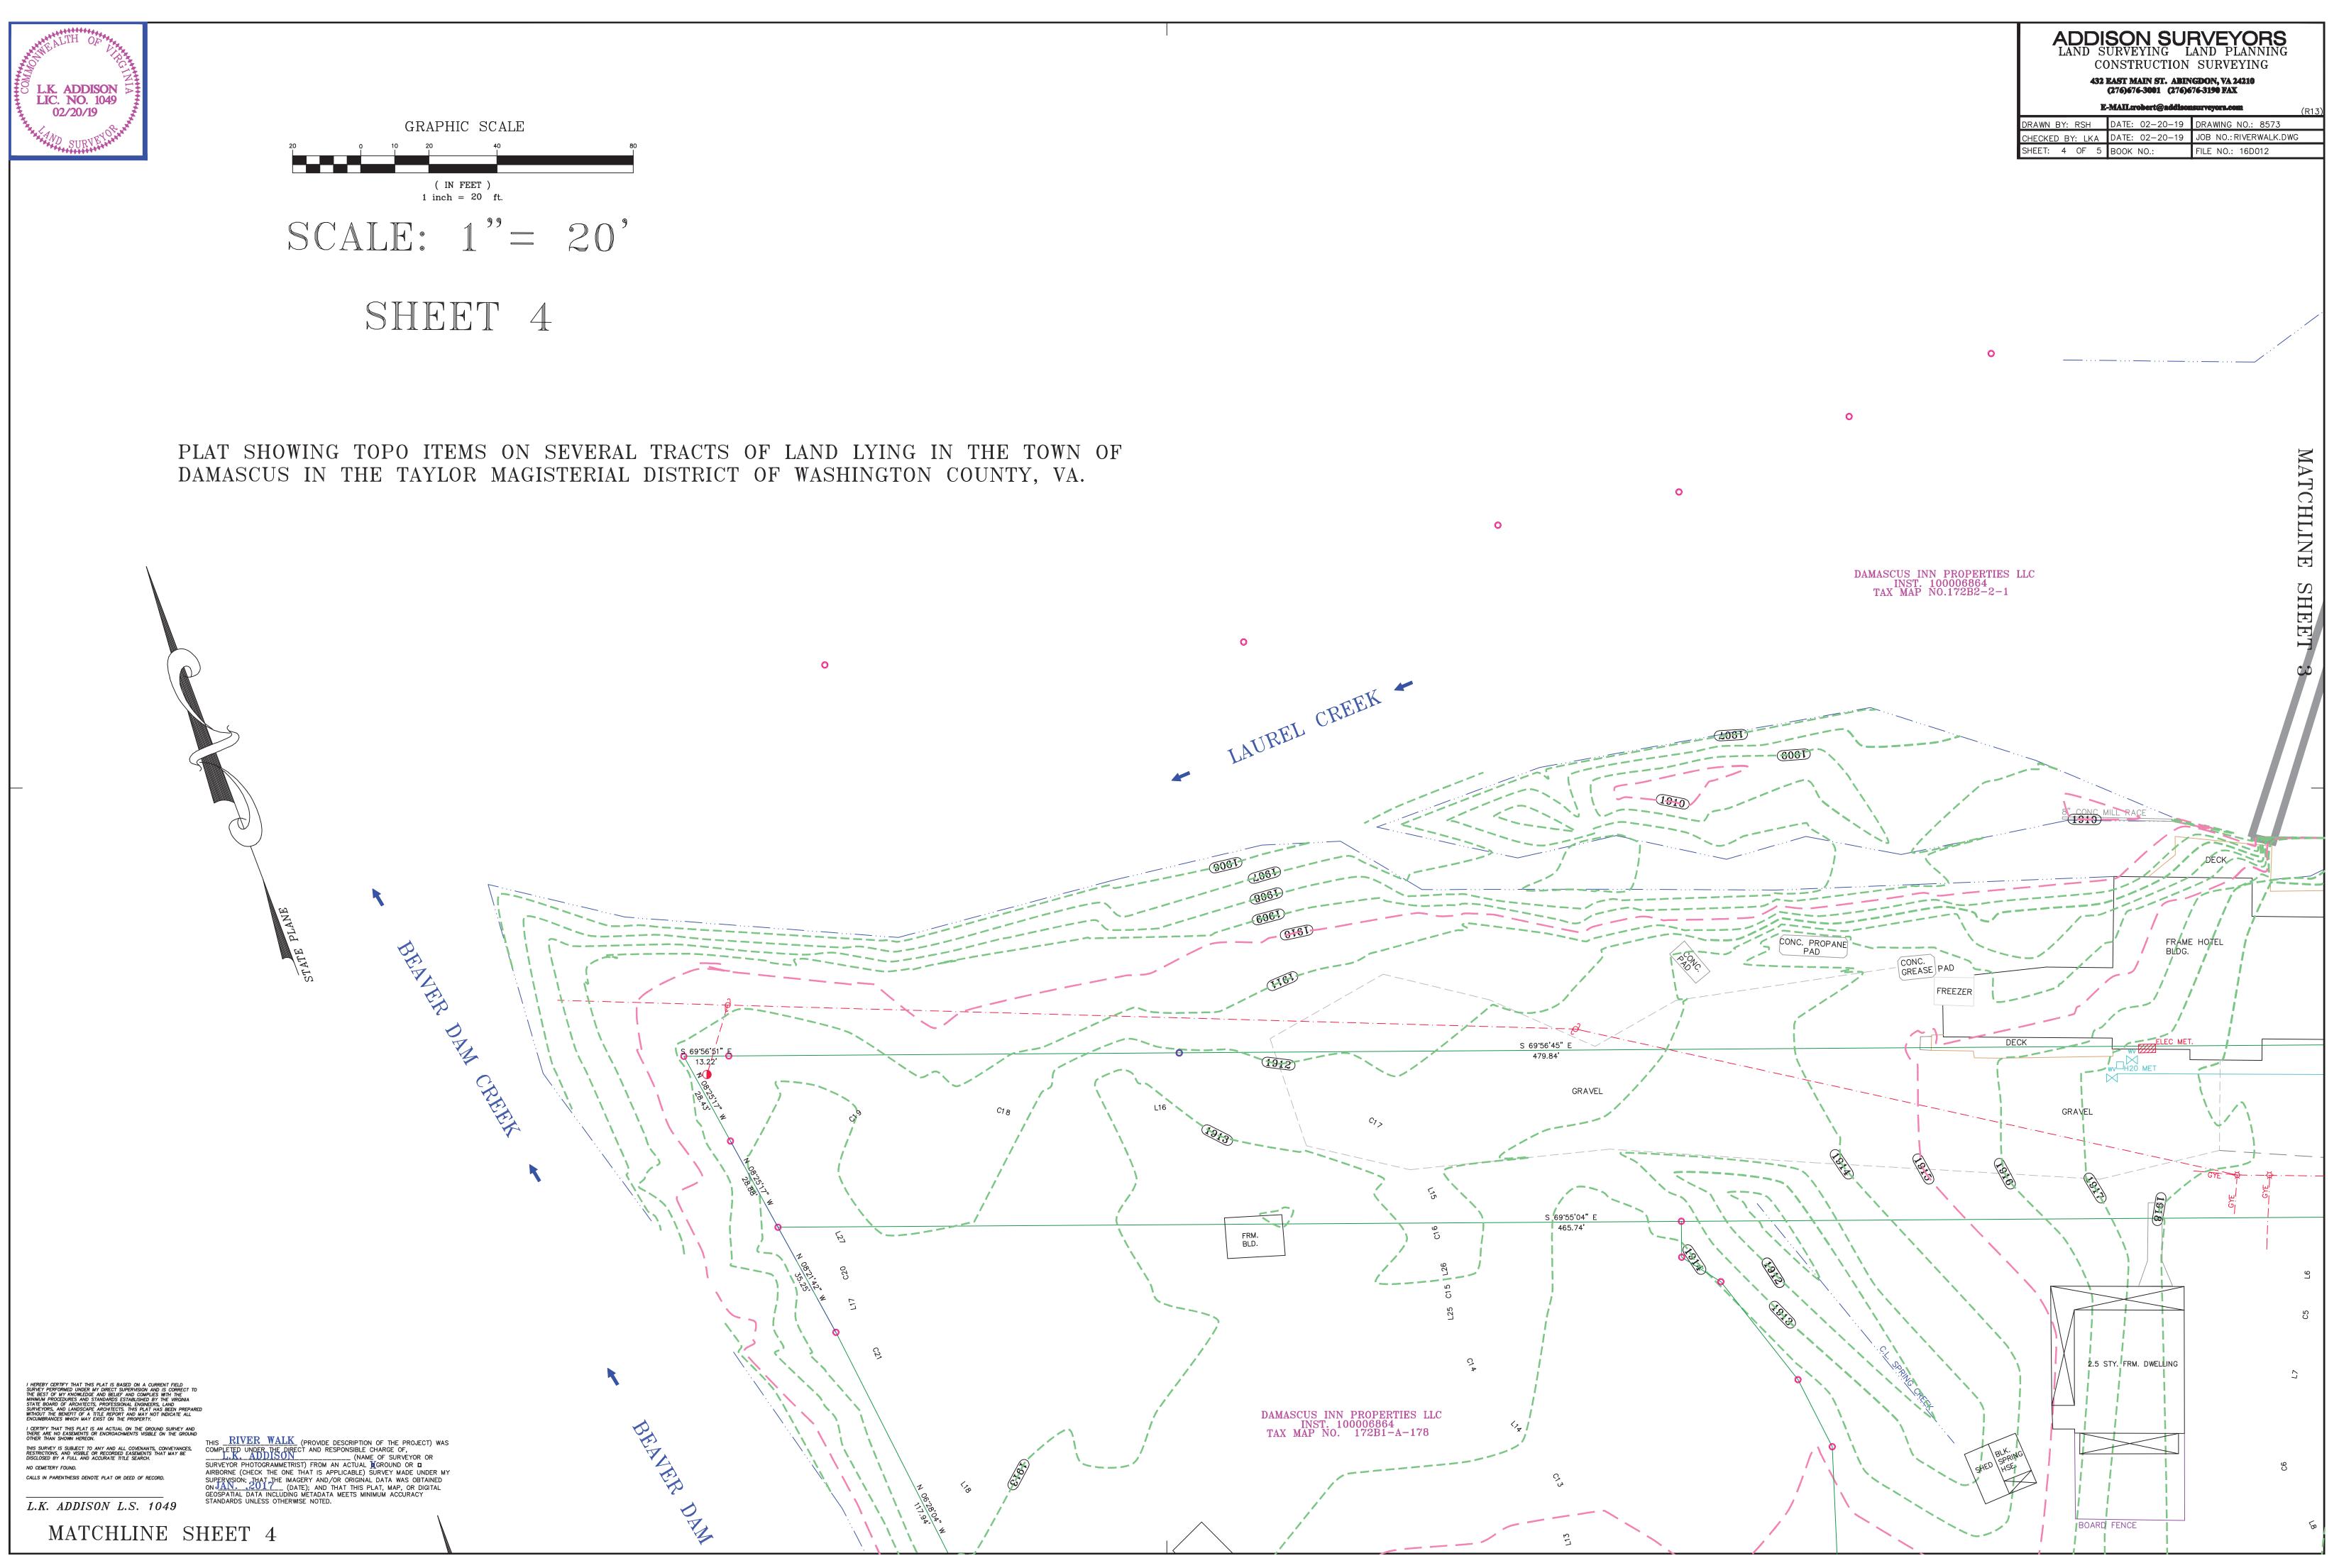


MATCHLINE SHEET 5

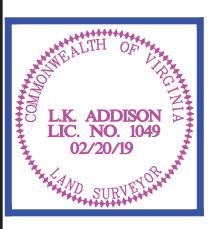

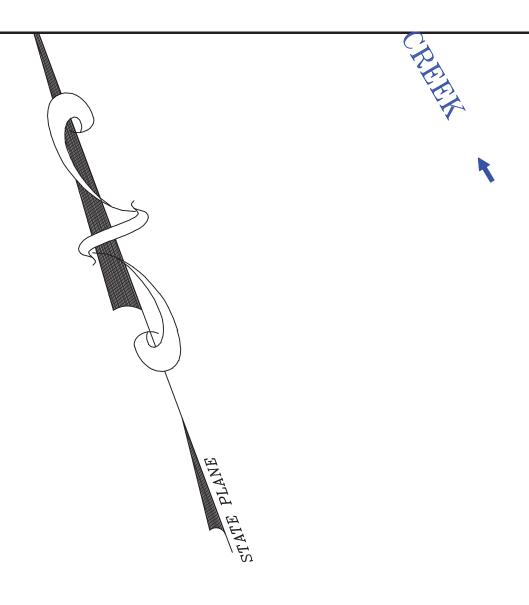


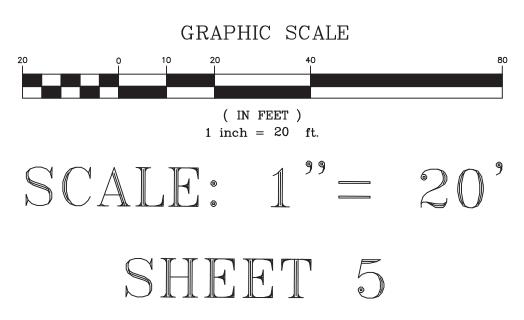

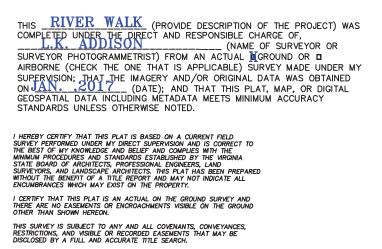


NO CEMETERY FOUND. CALLS IN PARENTHESIS DENOTE PLAT OR DEED OF RECORD.


L.K. ADDISON L.S. 1049

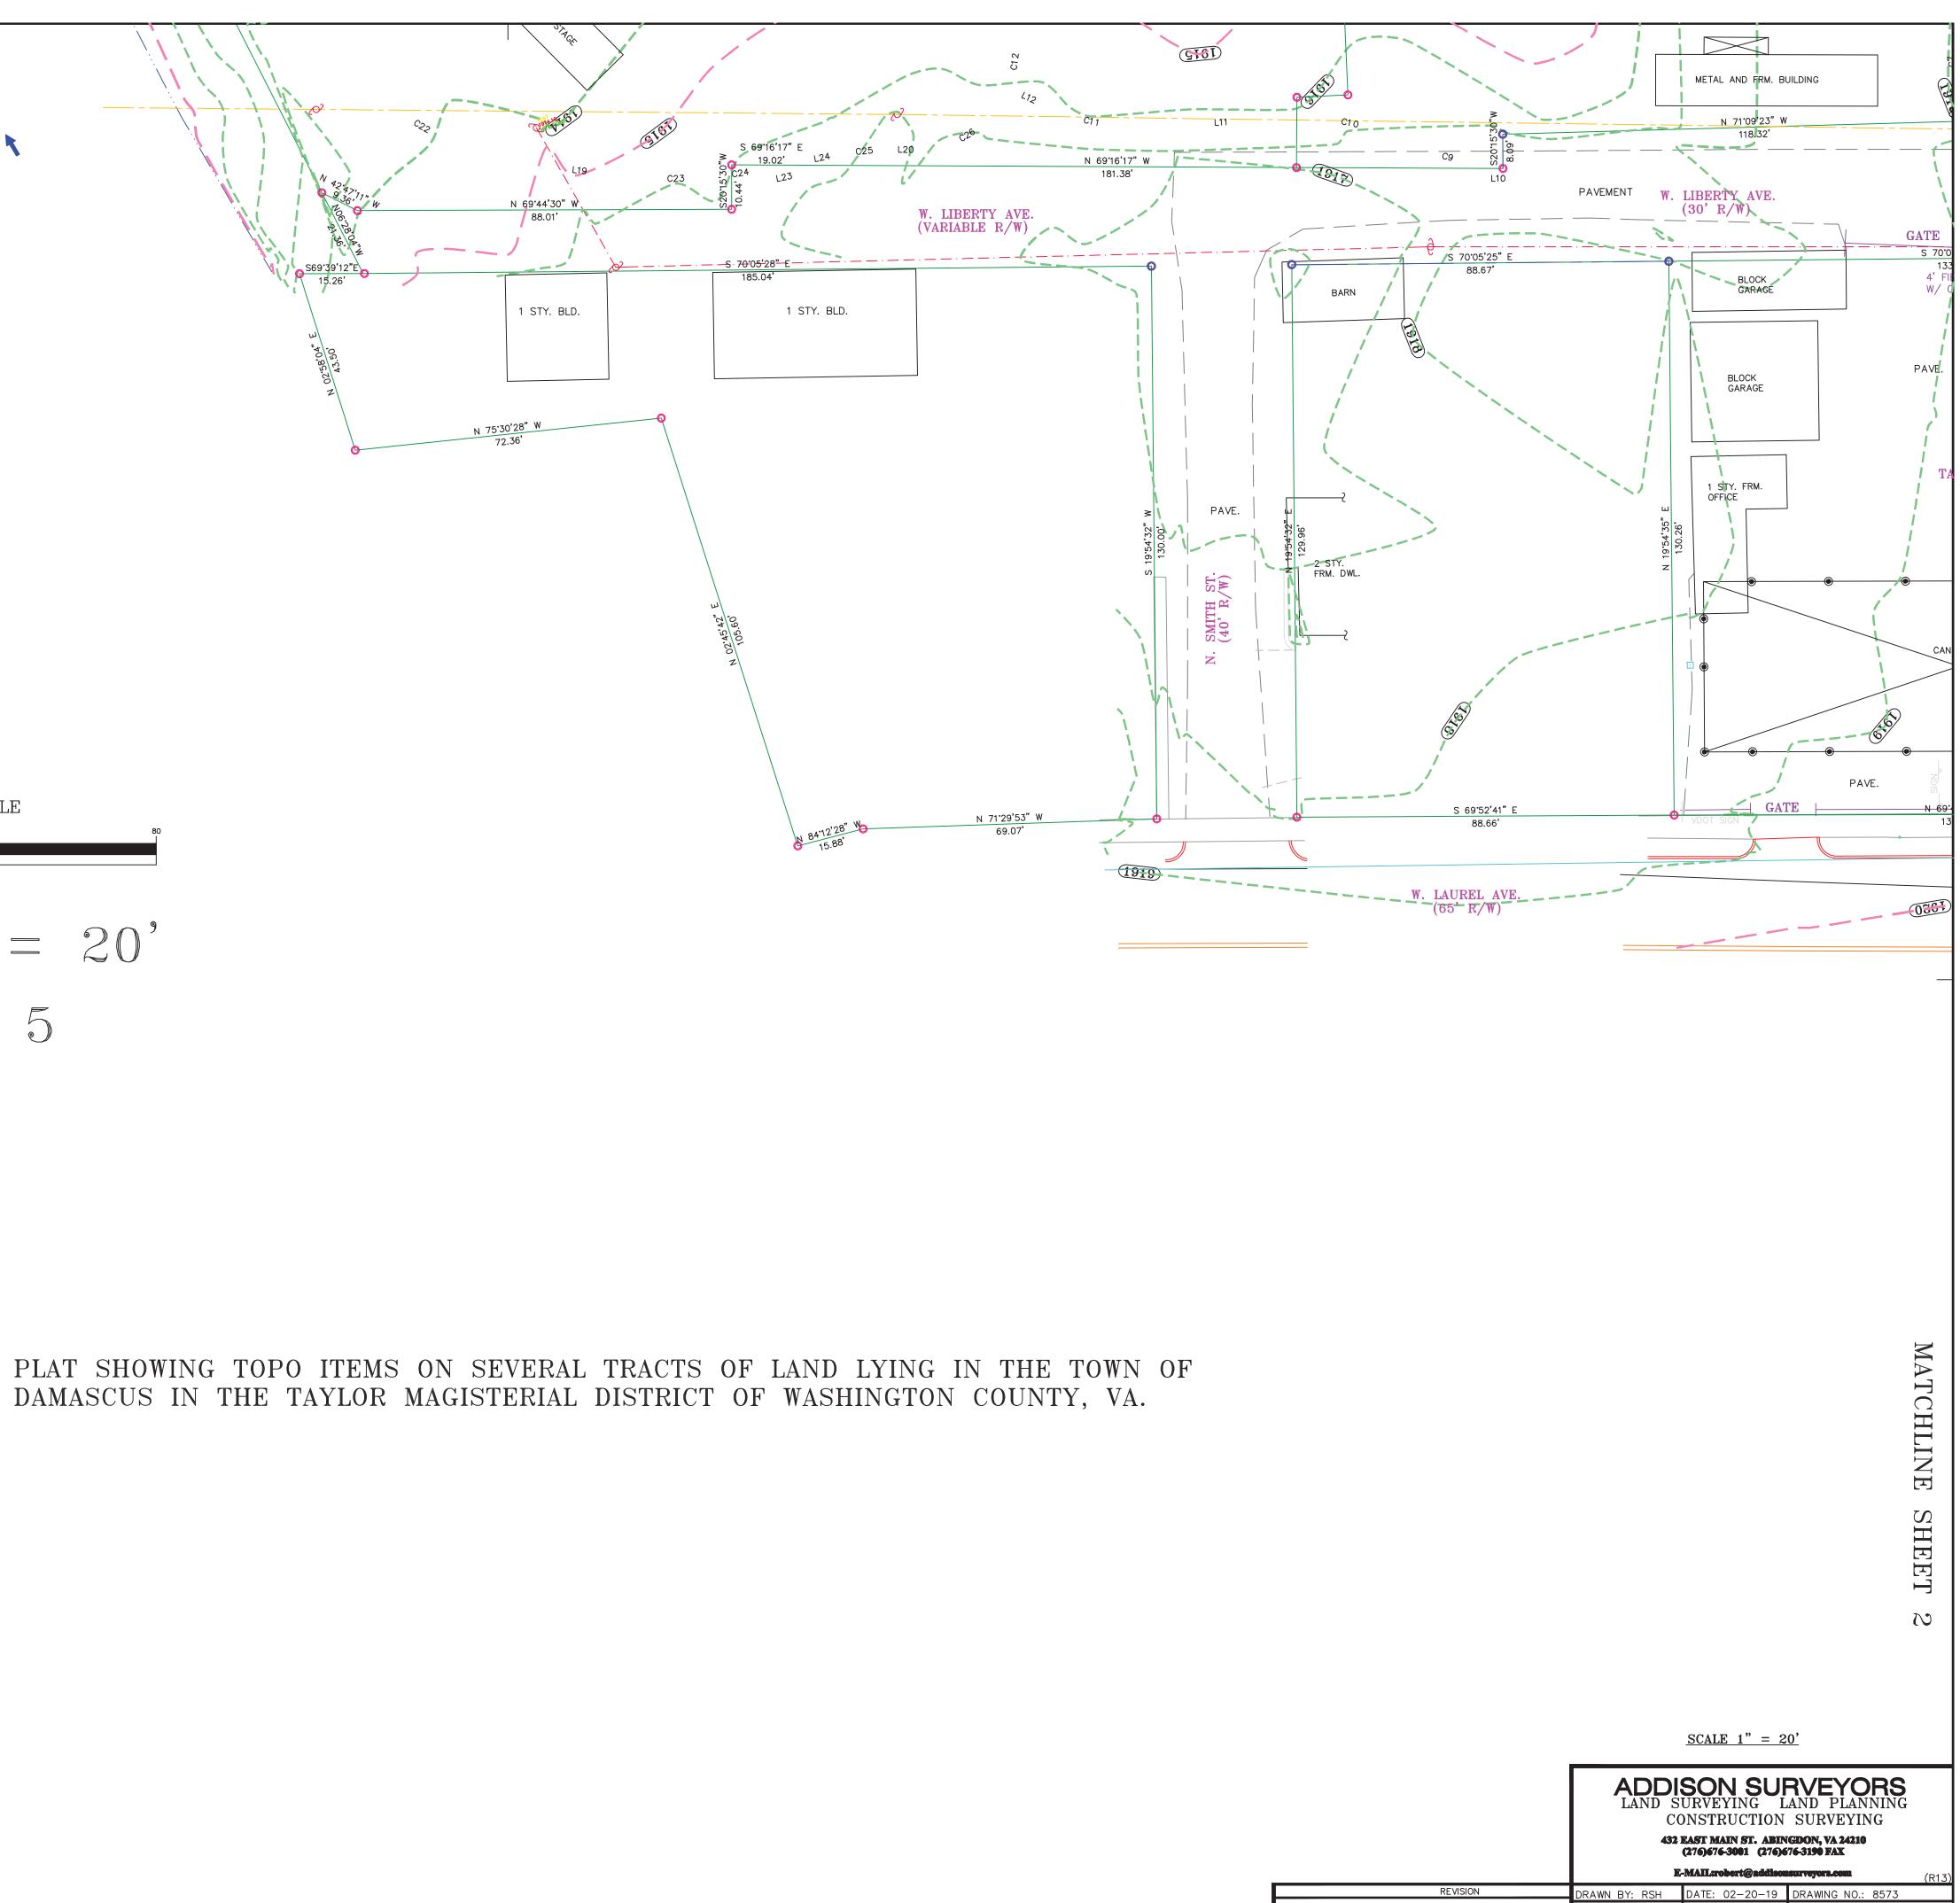



CHECKED BY: LKA DATE: 02-20-19 JOB NO.: RIVERWALK.DWG FILE NO.: 16D012 SHEET: 5 OF 5 BOOK NO .:

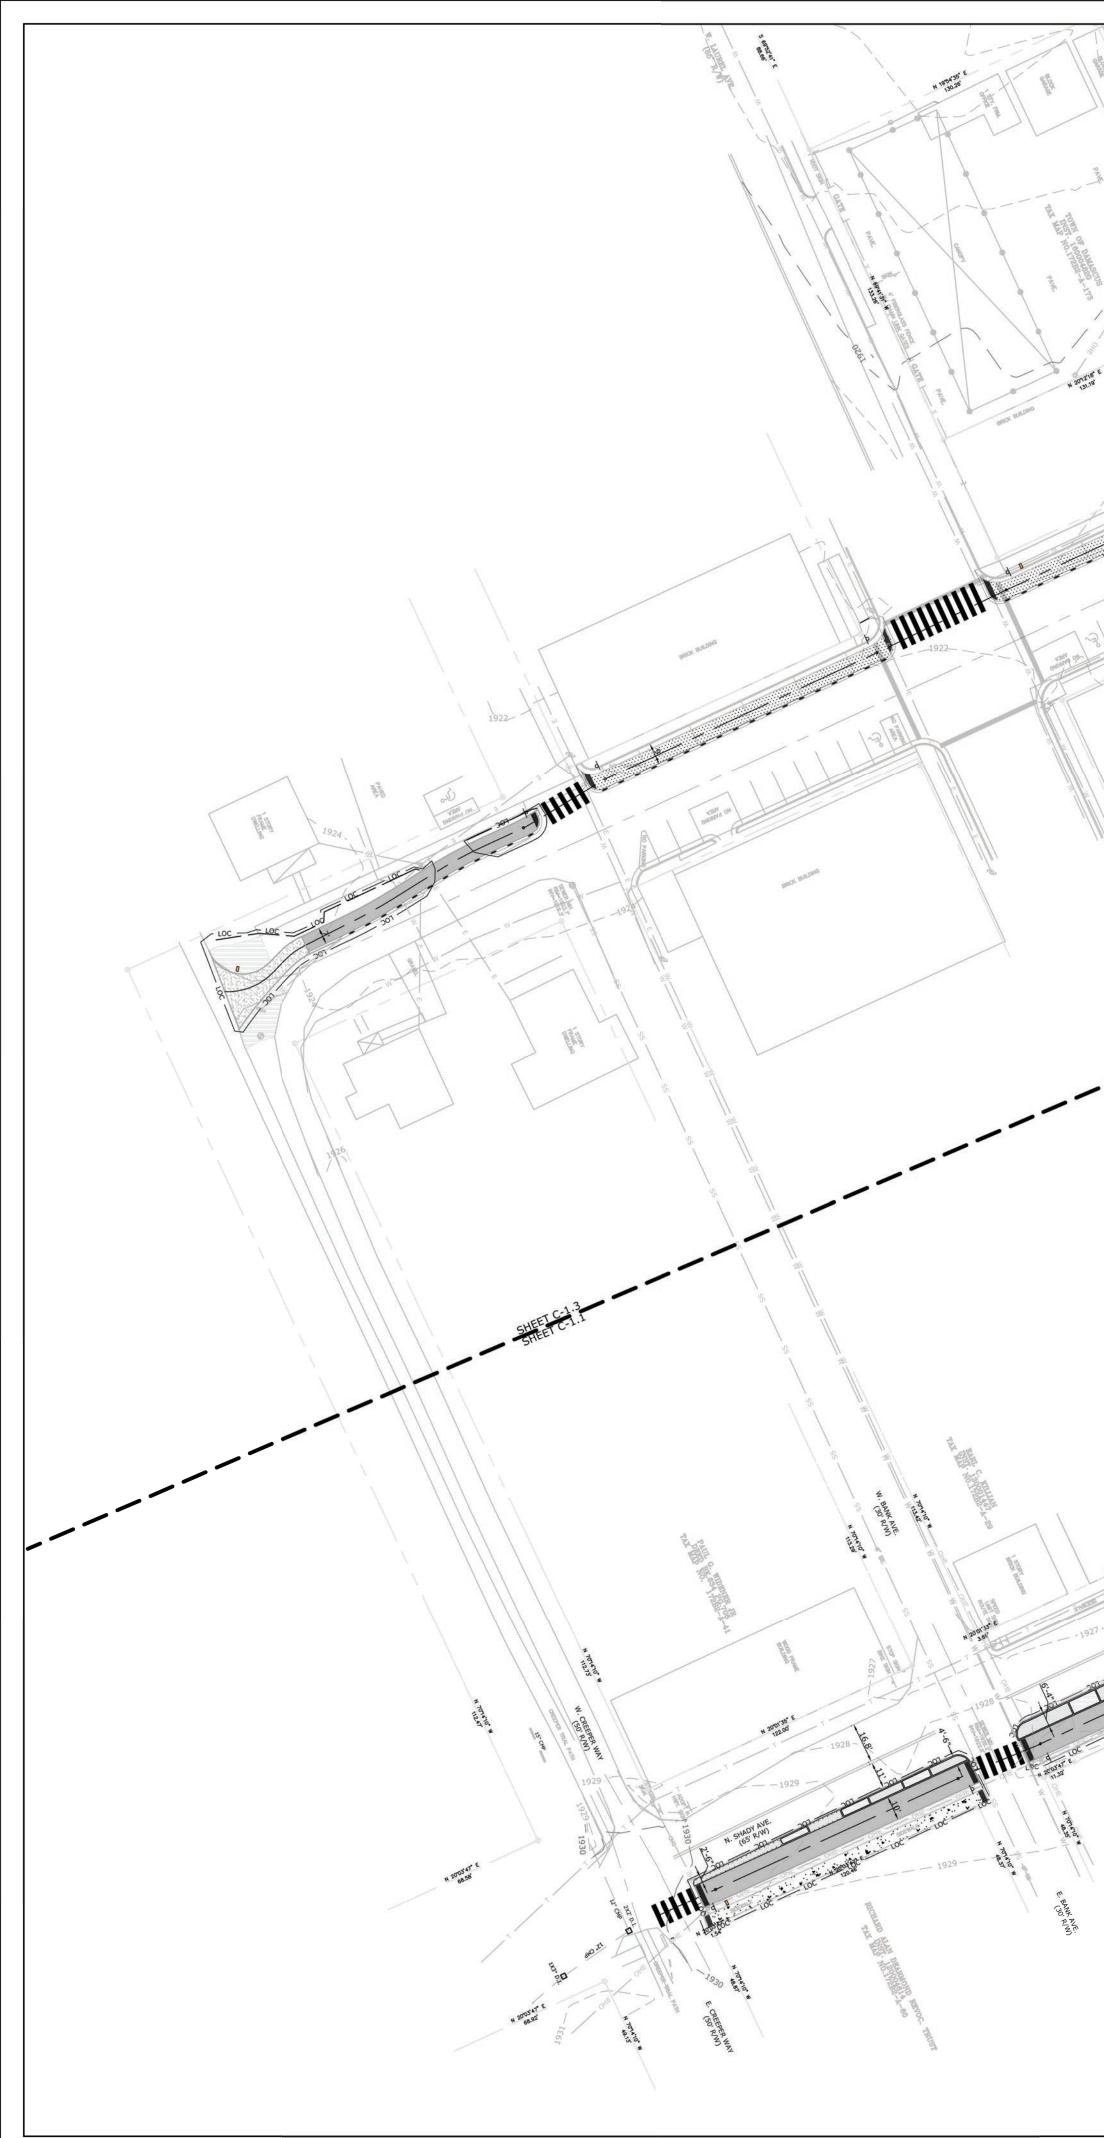



BE B	
LEGEND	
PROPOSED CRUSHER FINES TRAIL PROPOSED CONCRETE LIMIDSCAPED AREA PROPOSED PAVERS LIMITS OF DISTURBANCE PROPOSED SILT FENCE PROPOSED SILT FENCE PROPOSED BENCH PROPOSED SPLIT RAIL FENCE	

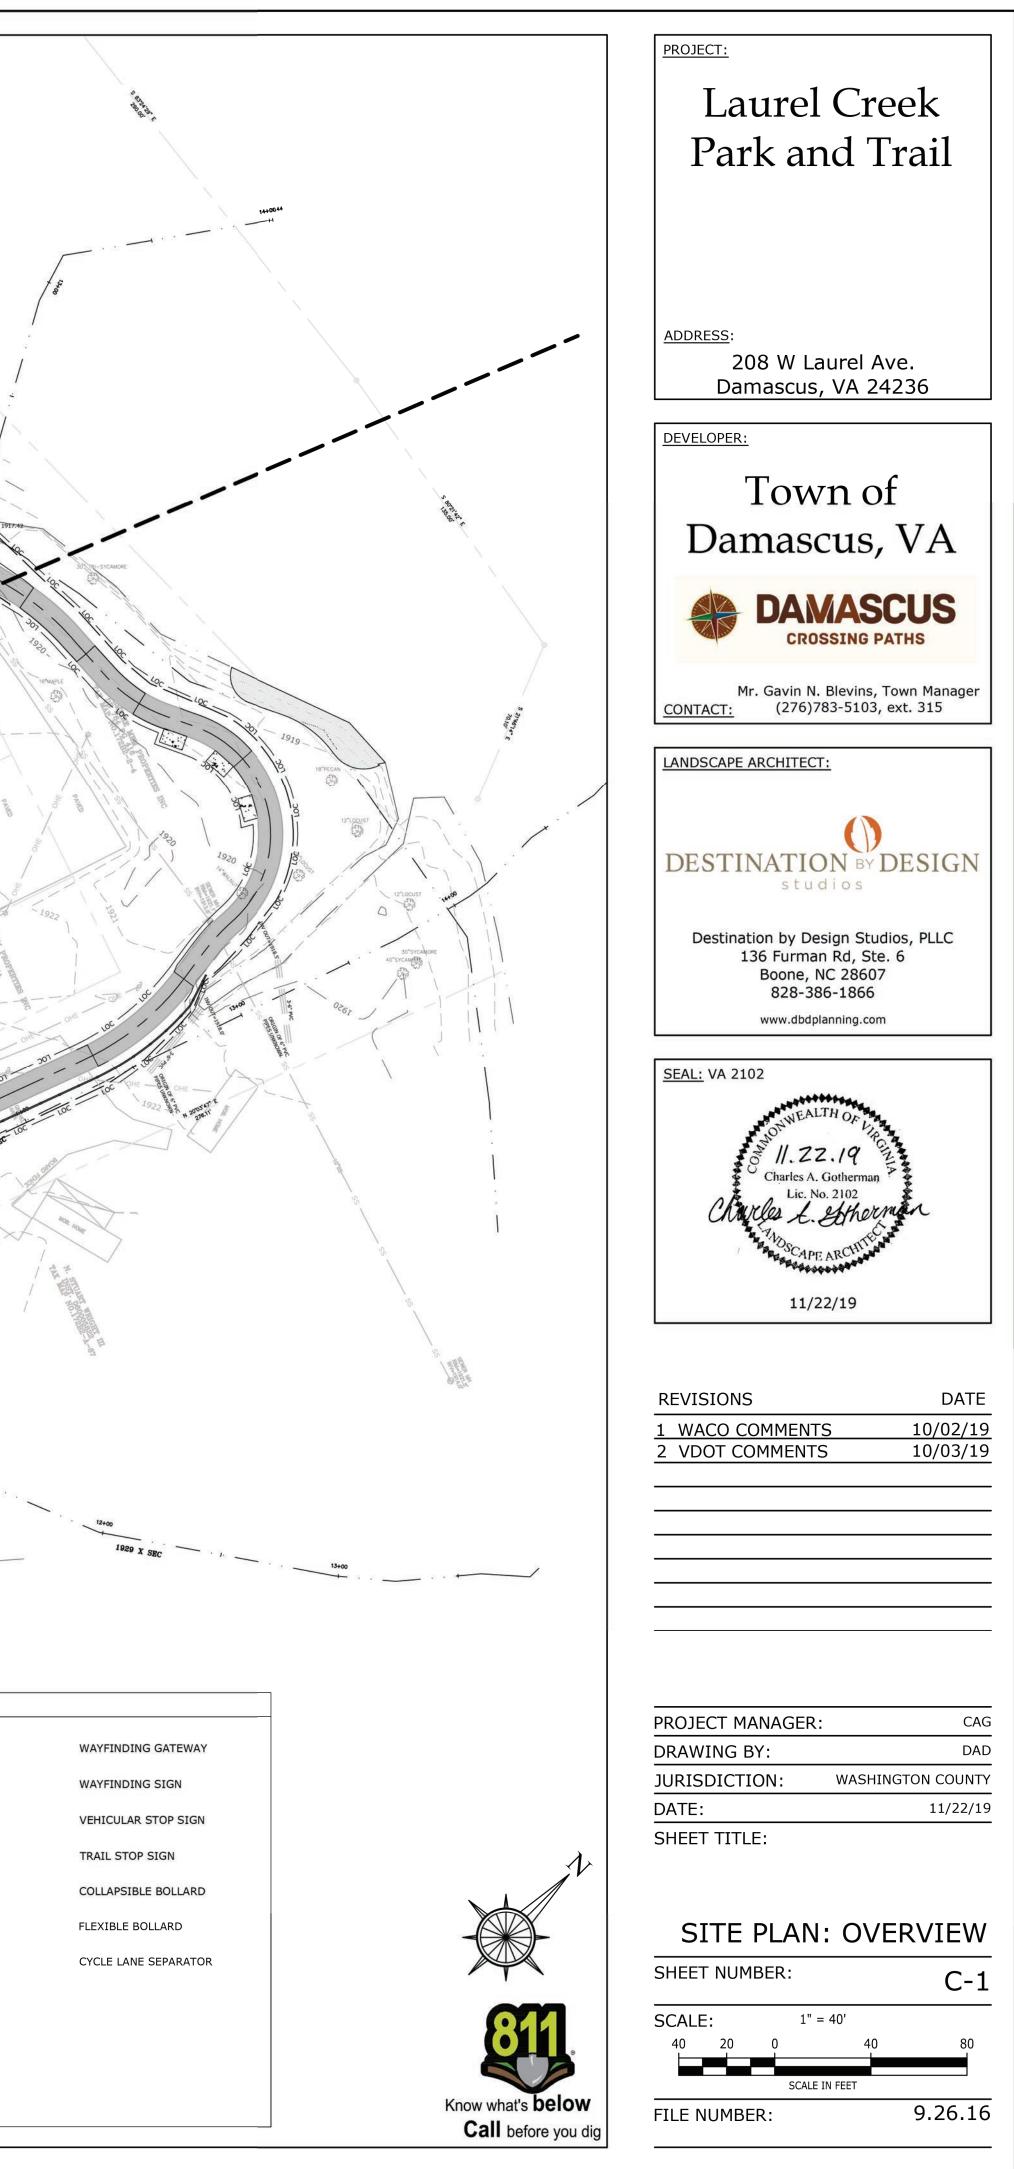

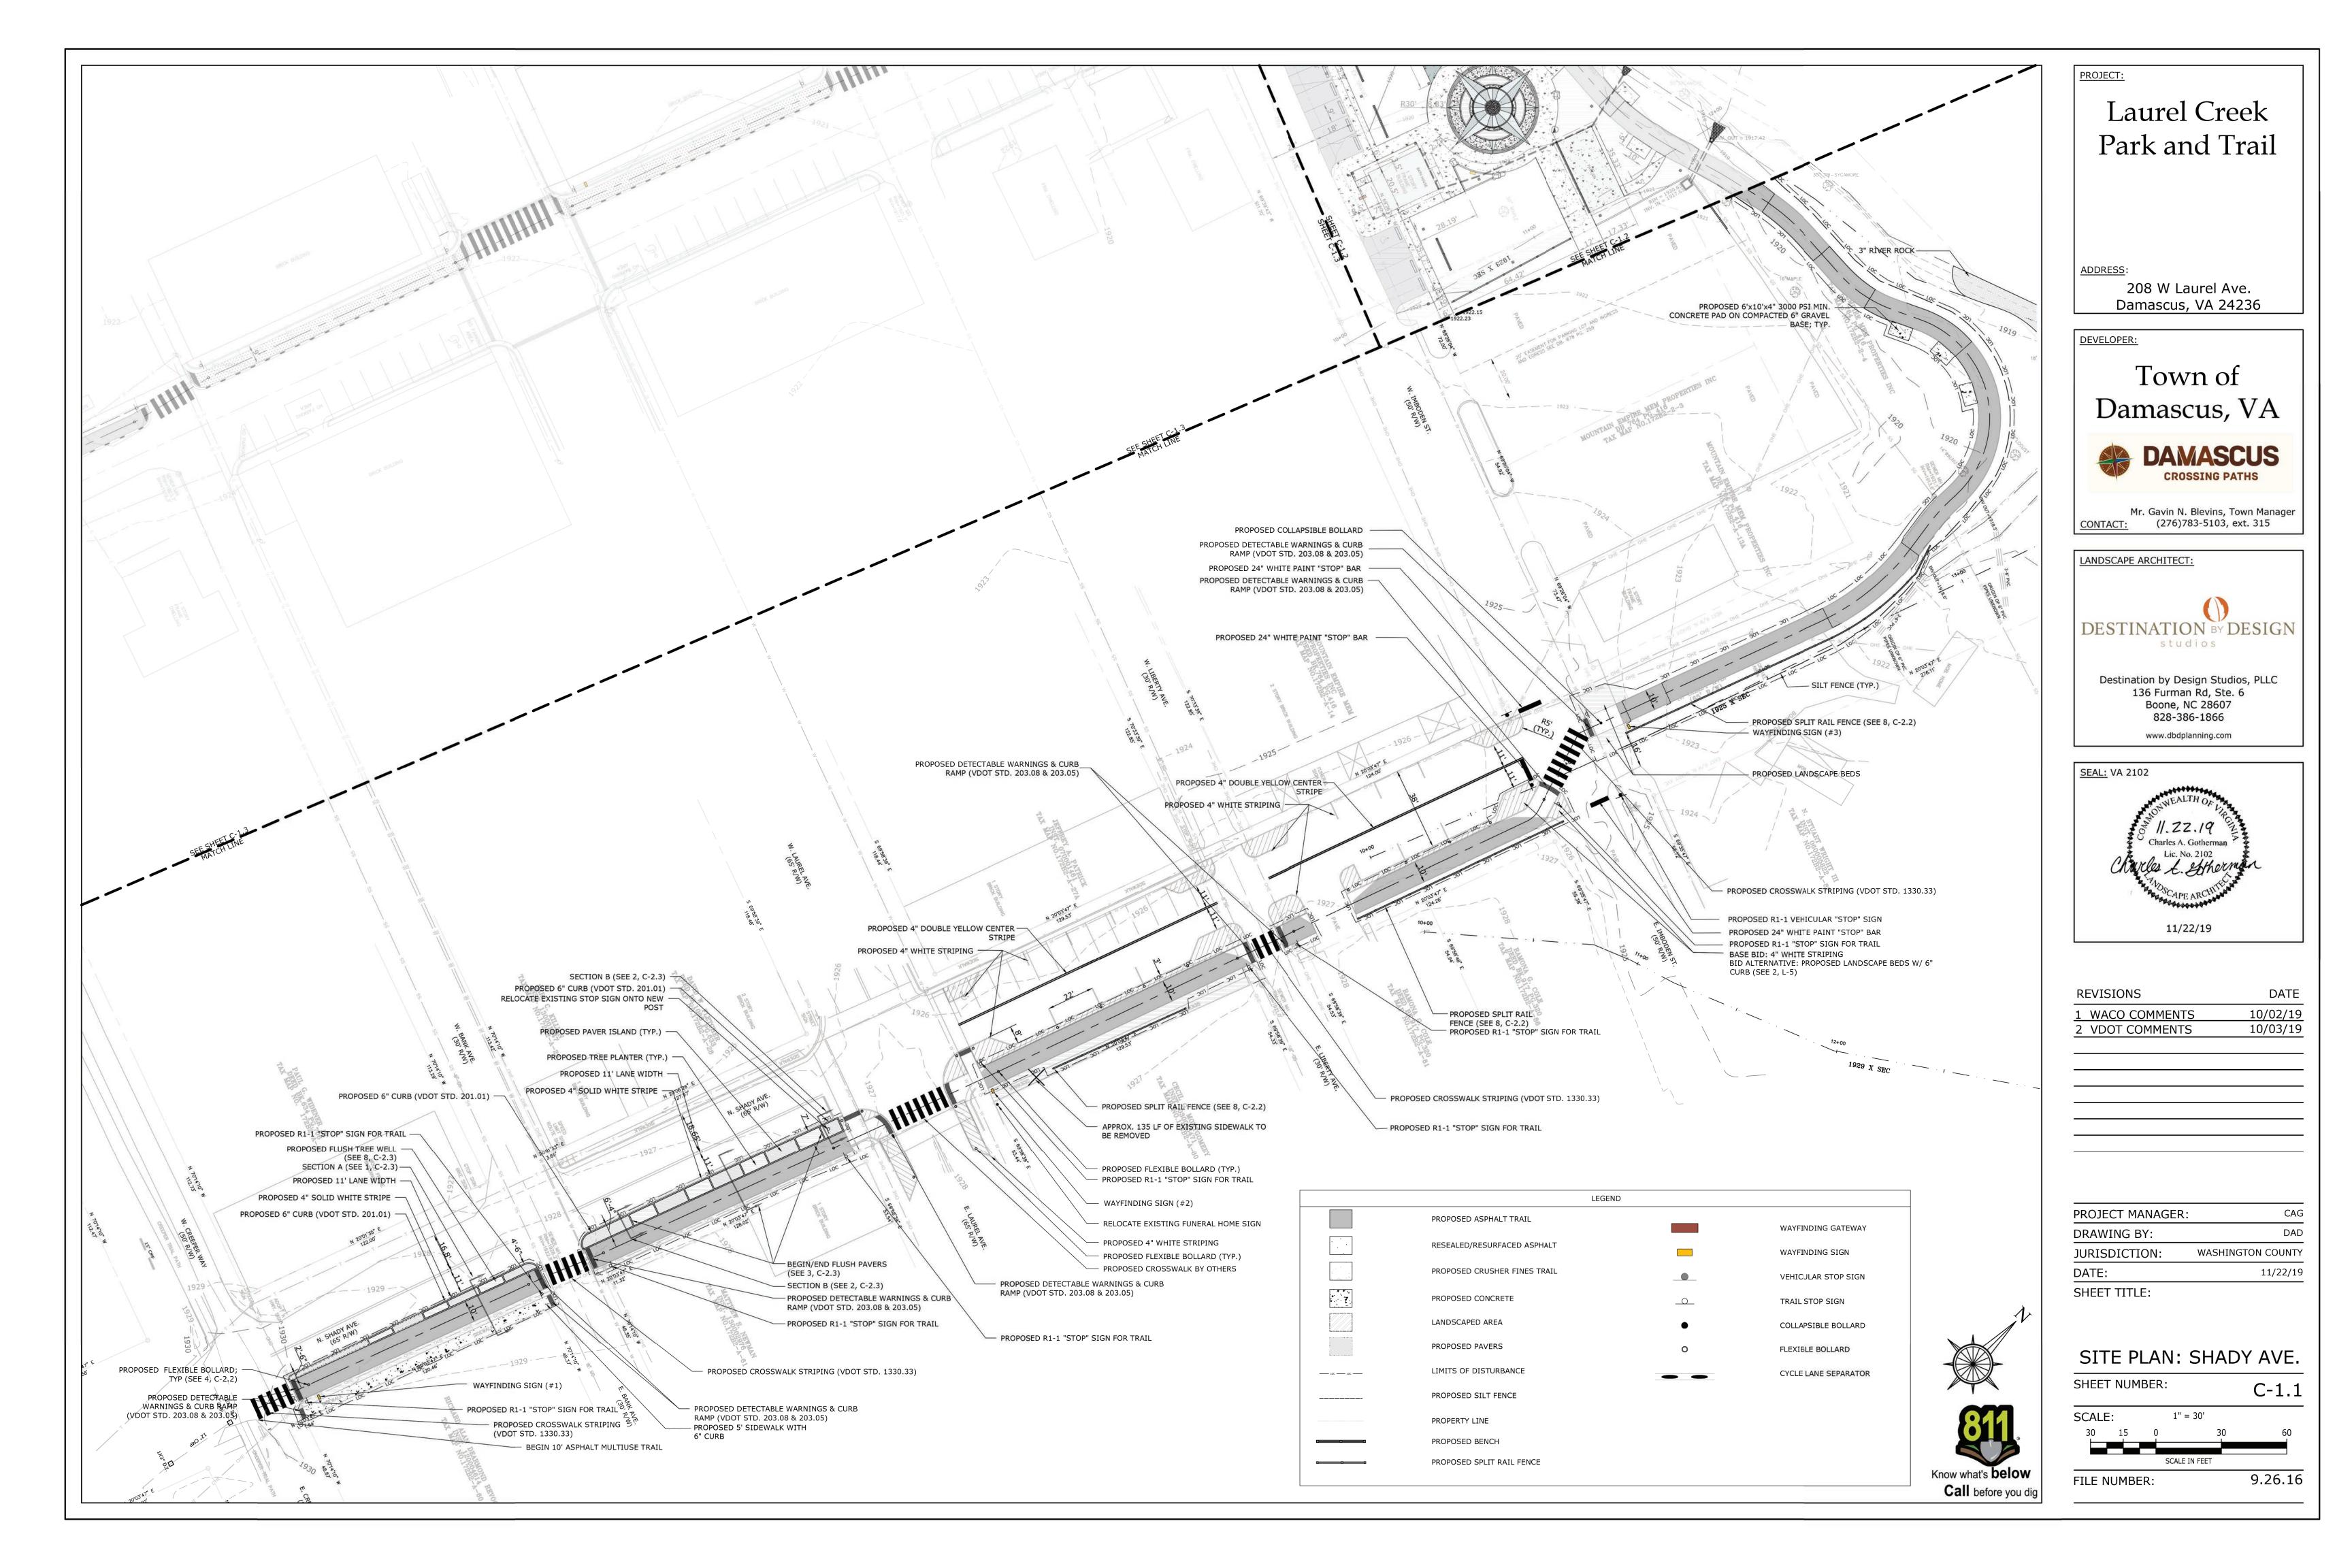

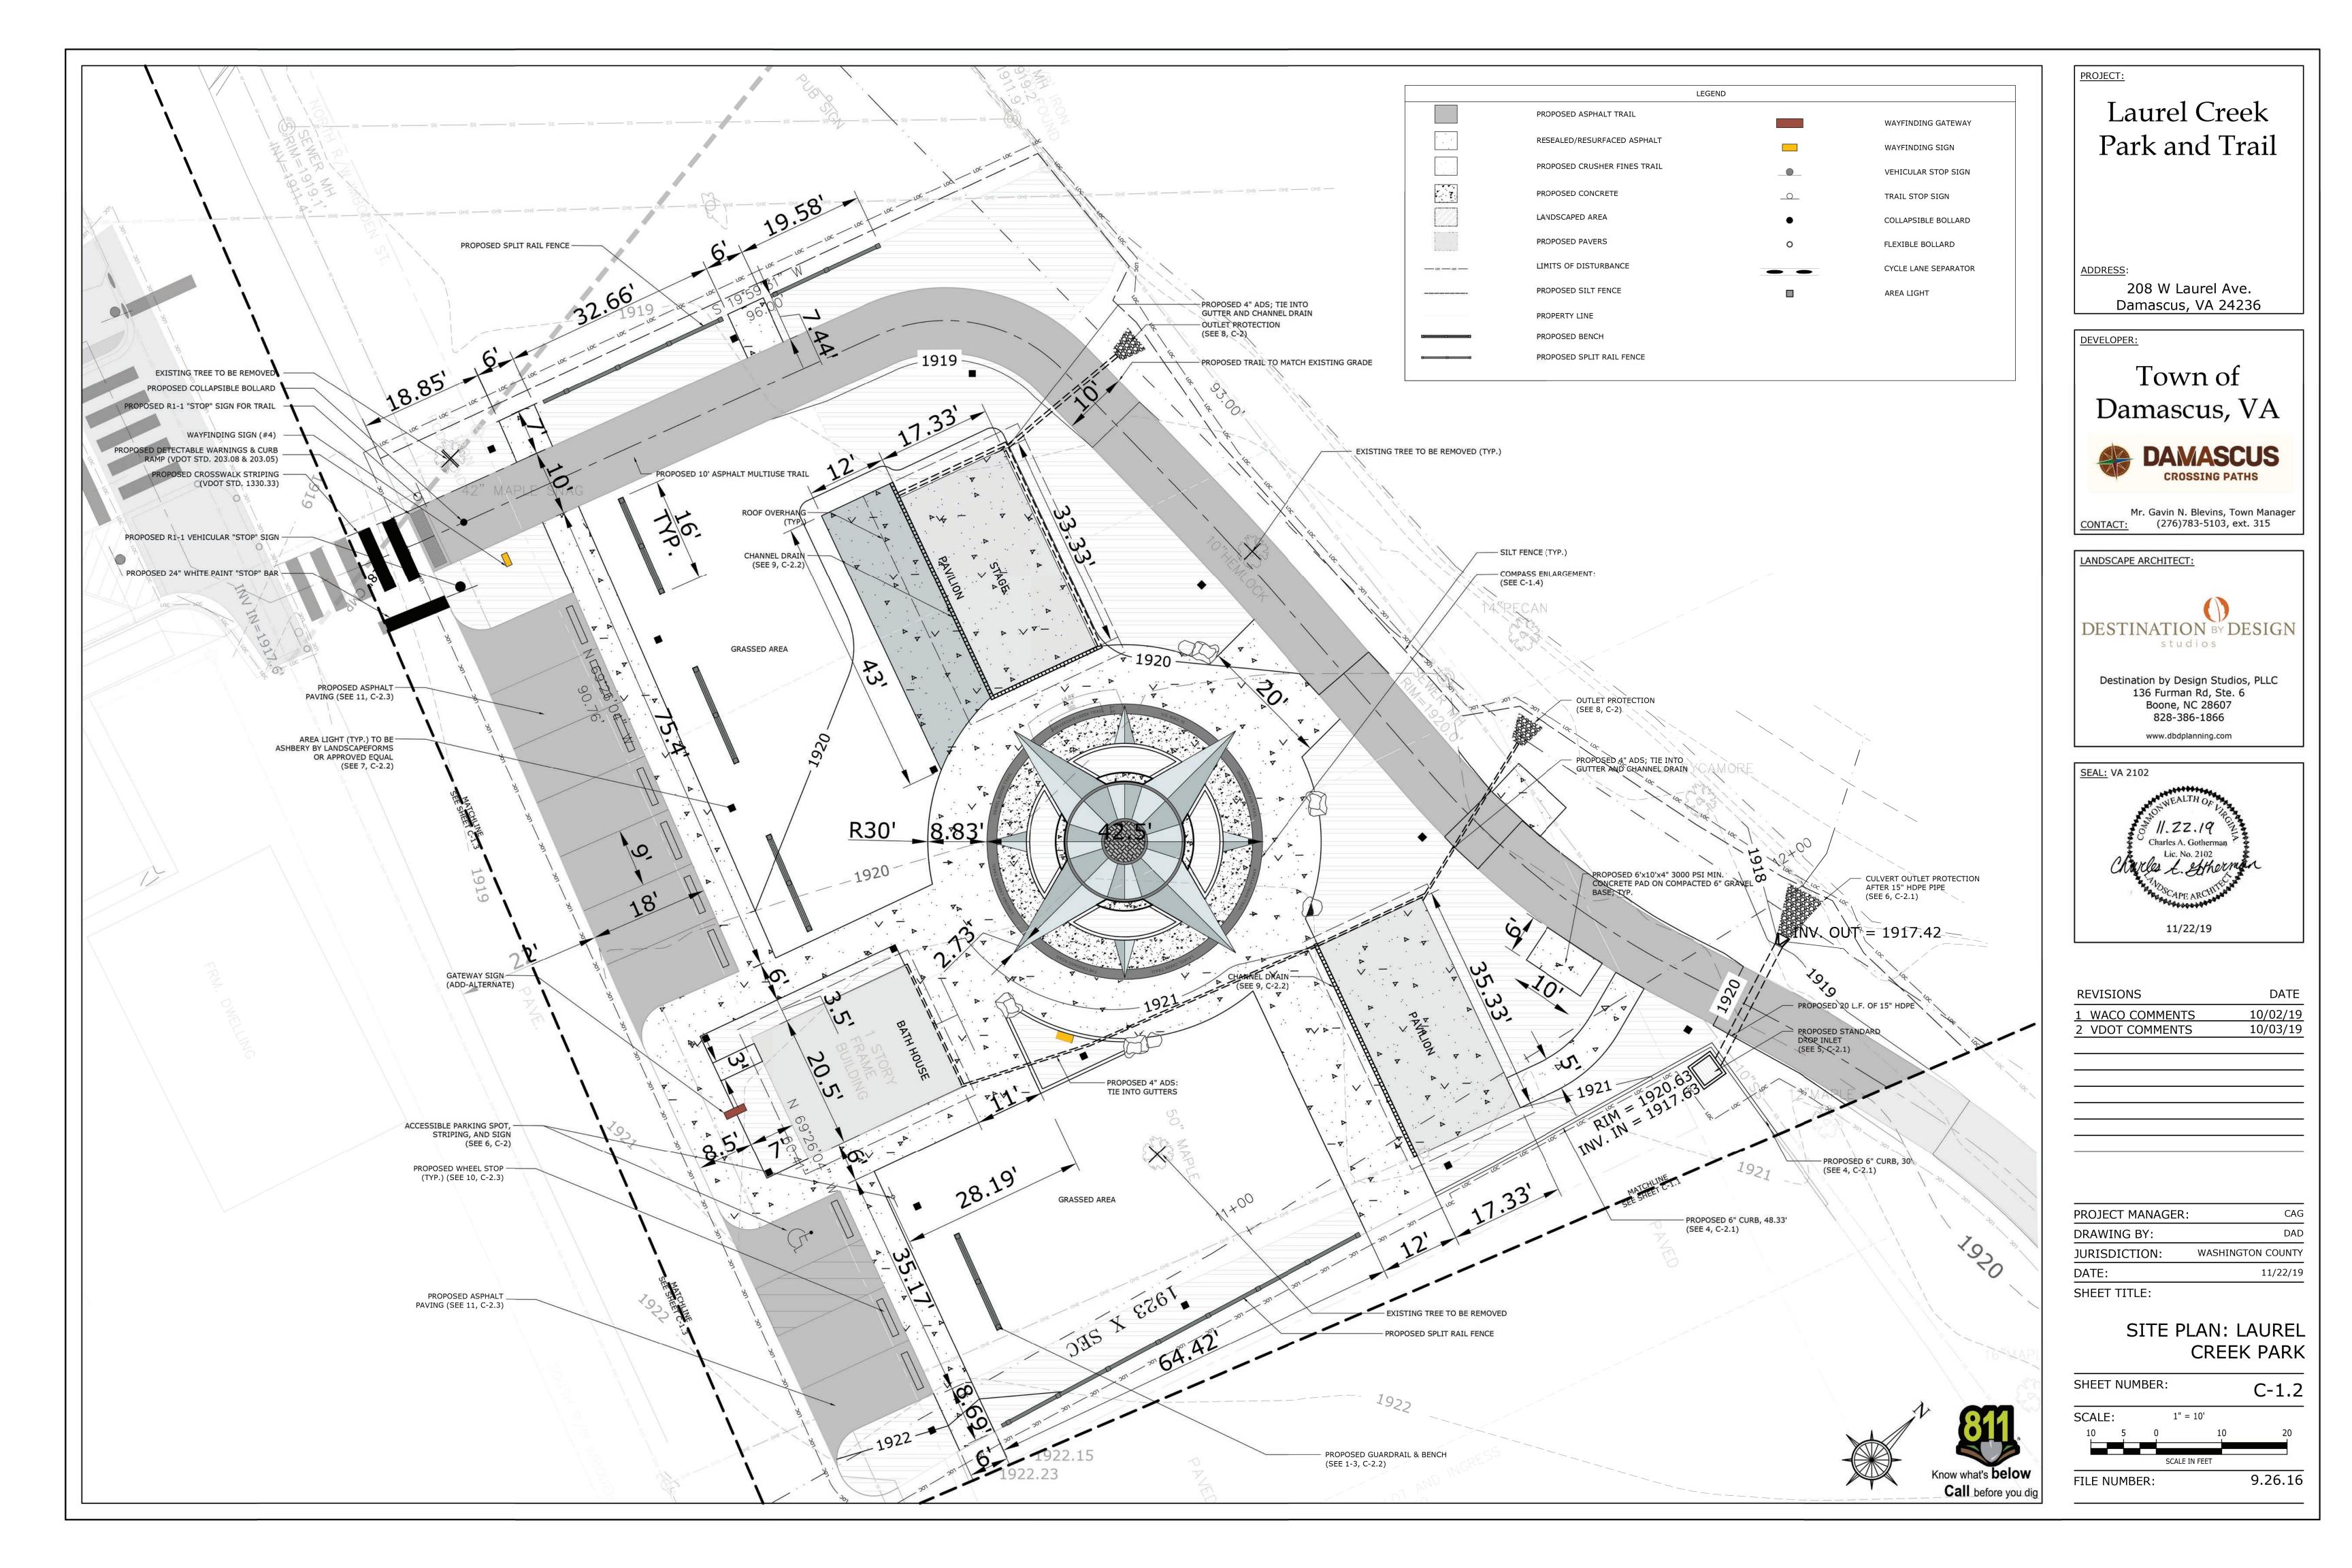

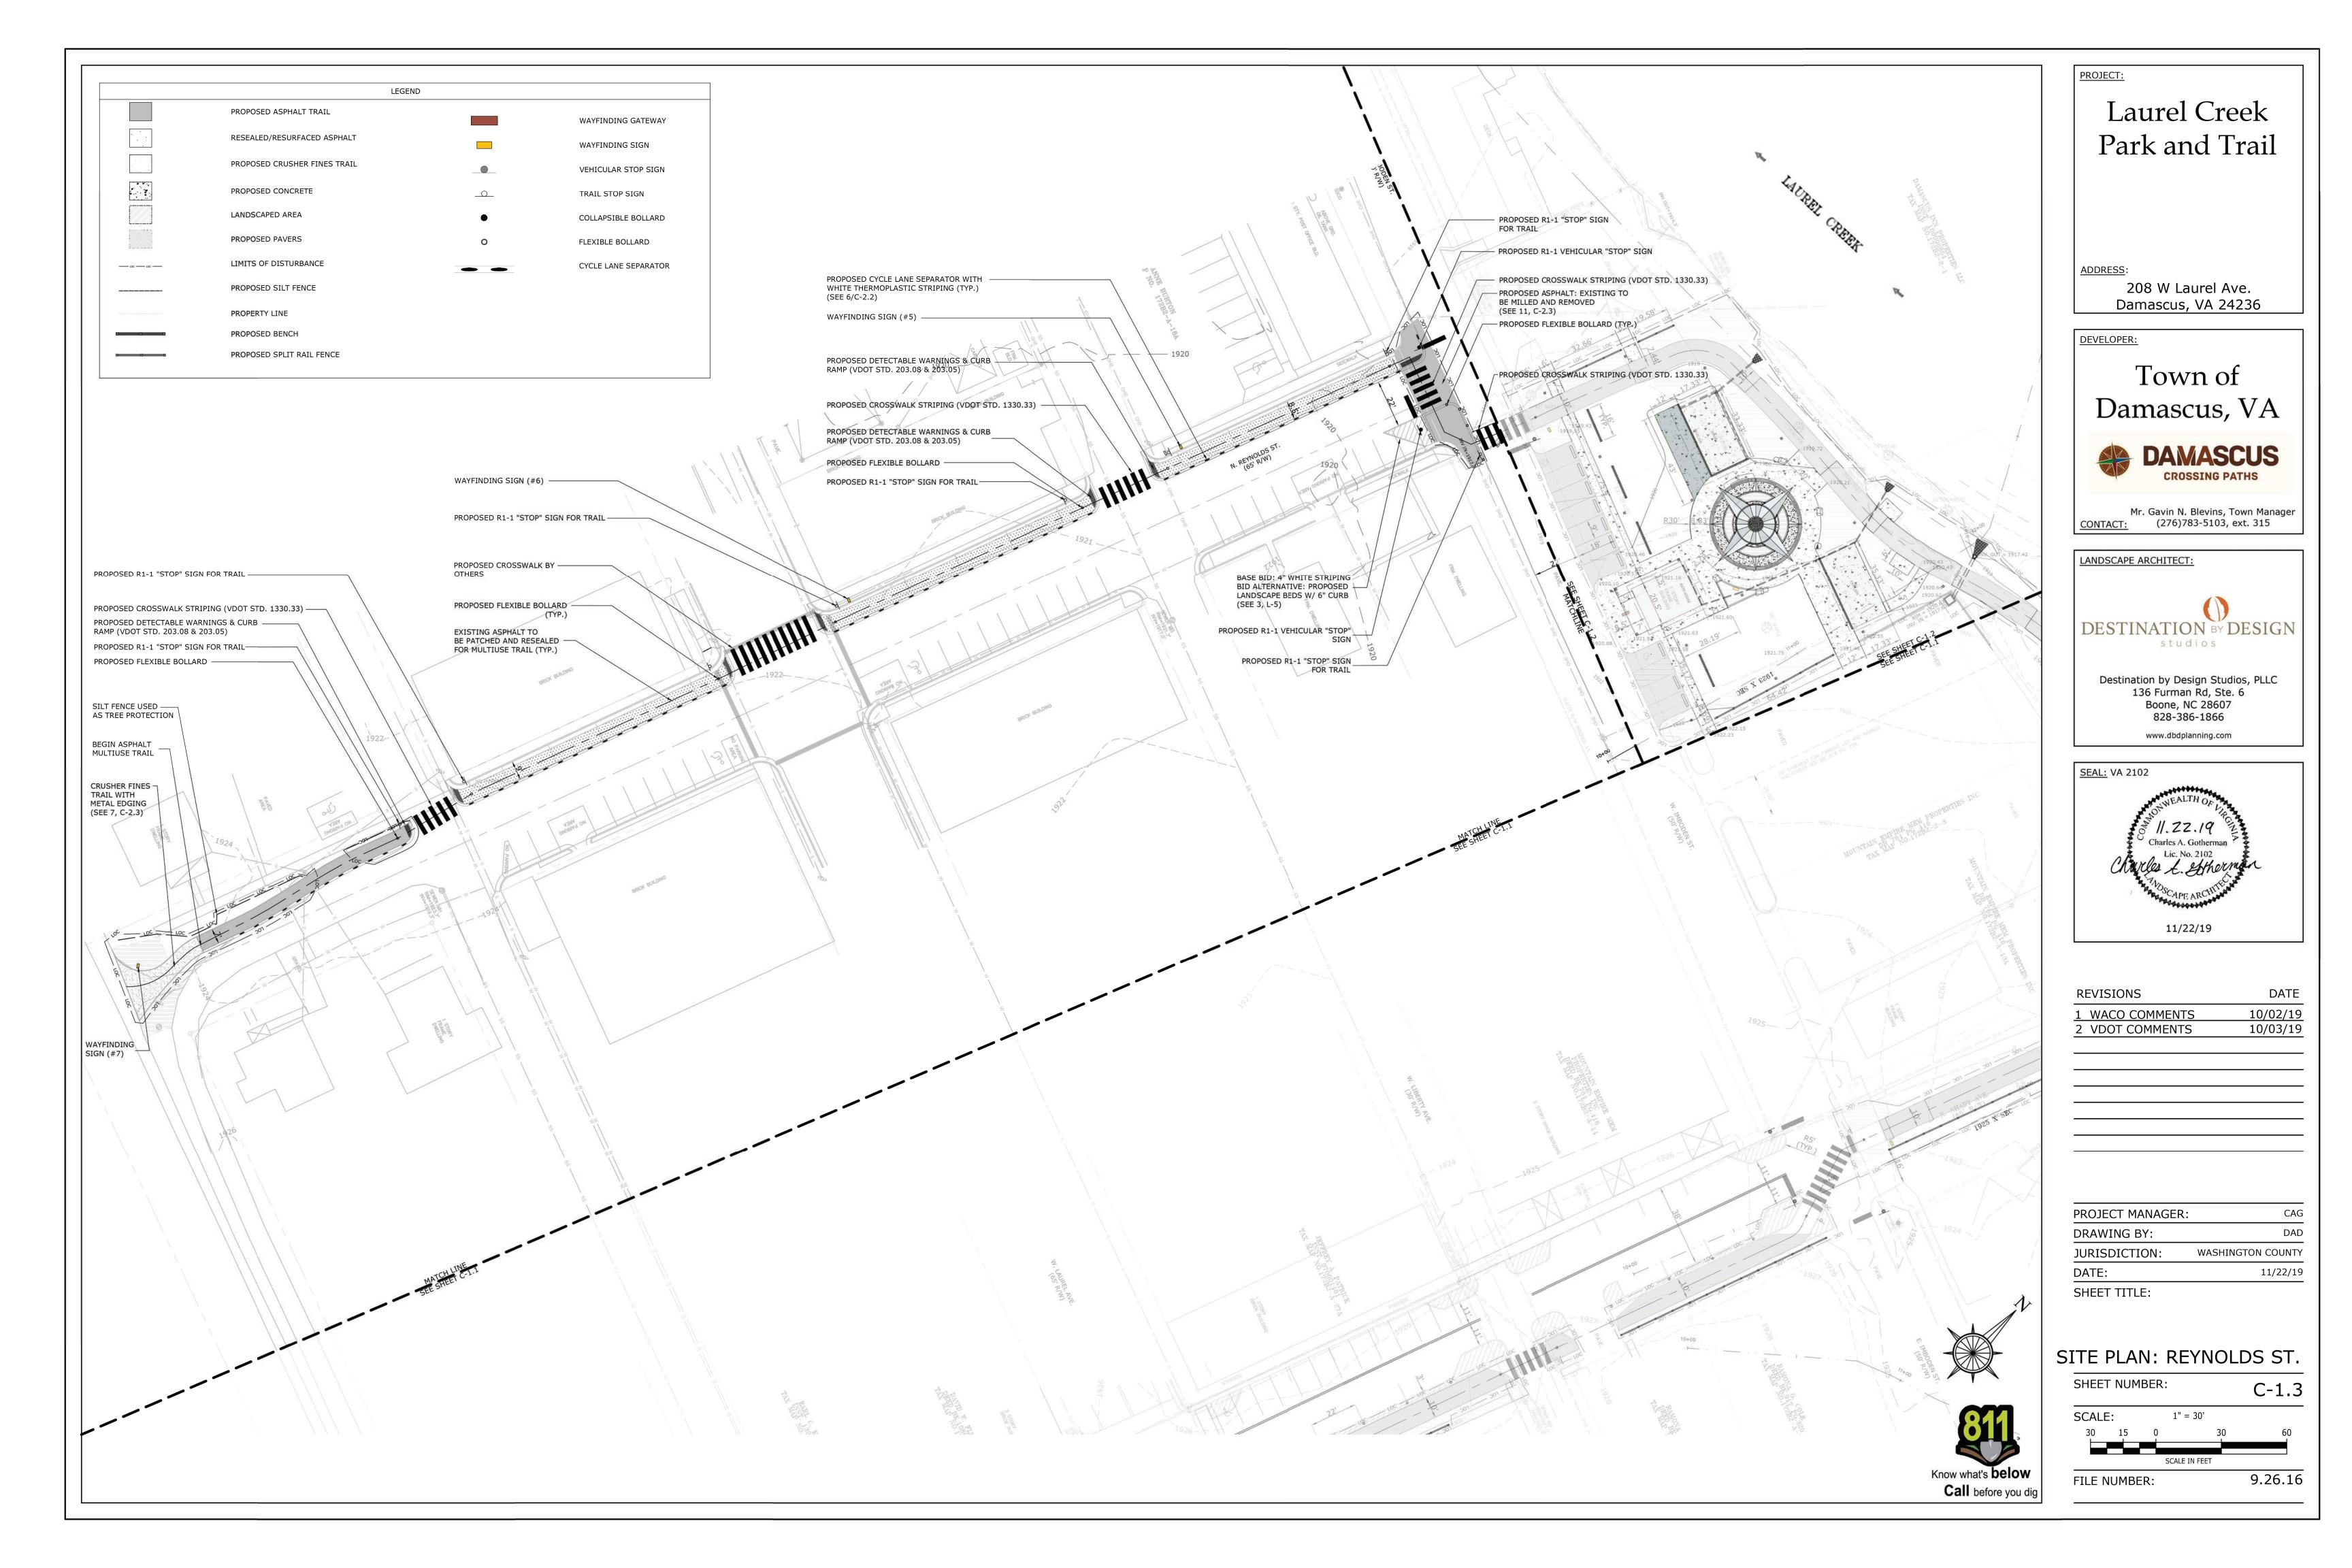

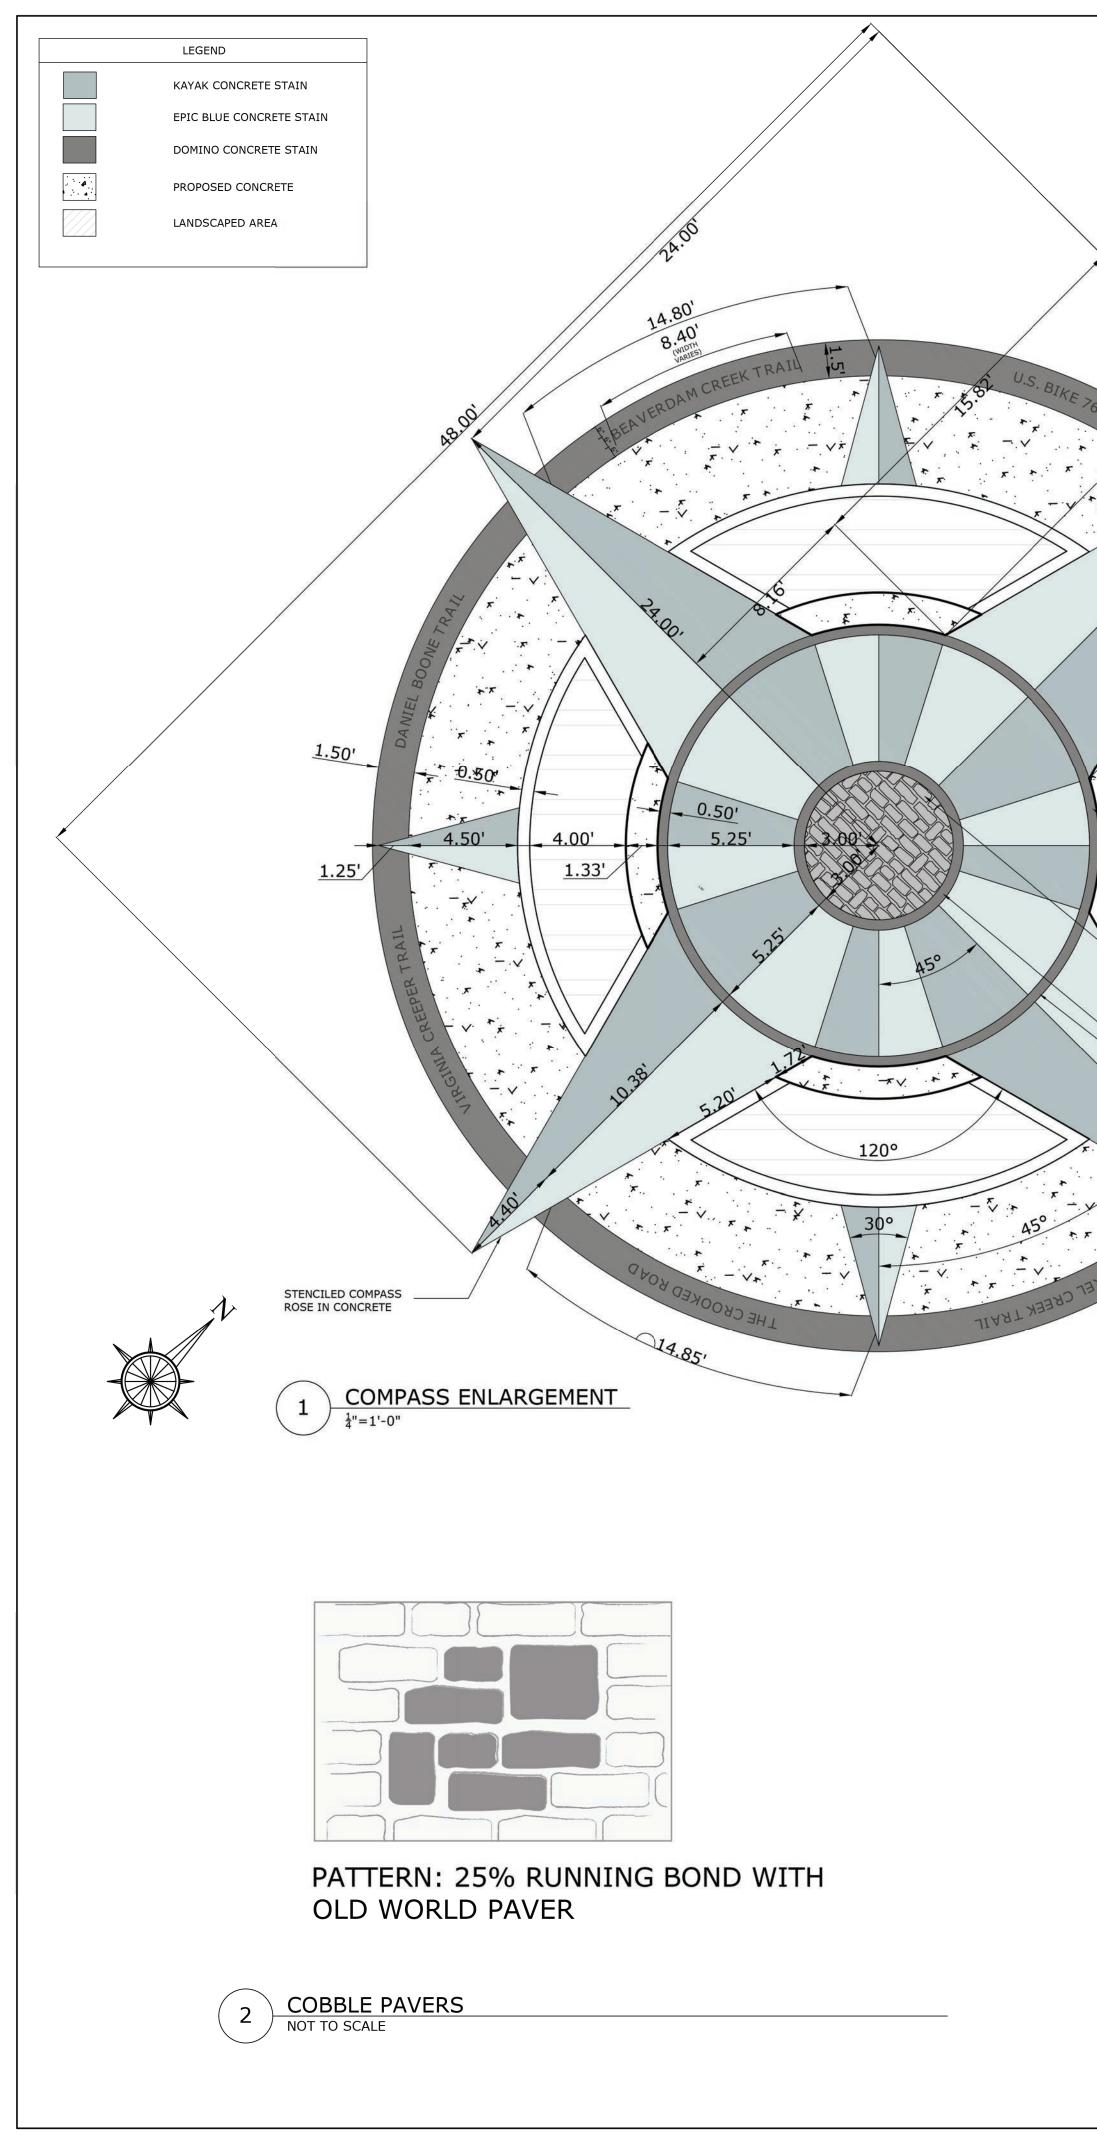

CONCRETE NOTES:


NOTE:

ALL CONCRETE STAIN TO BE "SEMI-TRANSPARENT CONCRETE STAIN WATER BASED ECO-STAIN BY SURECRETE" (OR EQUIVALENT)

ALL PRODUCT TO BE INSTALLED TO MANUFACTURER'S SPECIFICATIONS

IN ADDITION TO STAIN APPLICATION, A NON-SLIP SEALER SHALL BE APPLIED

CONCRETE SHALL BE 5000 PSI STRENGTH WITH FIBER REINFORCEMENT WITH SPECIFIED FINISH

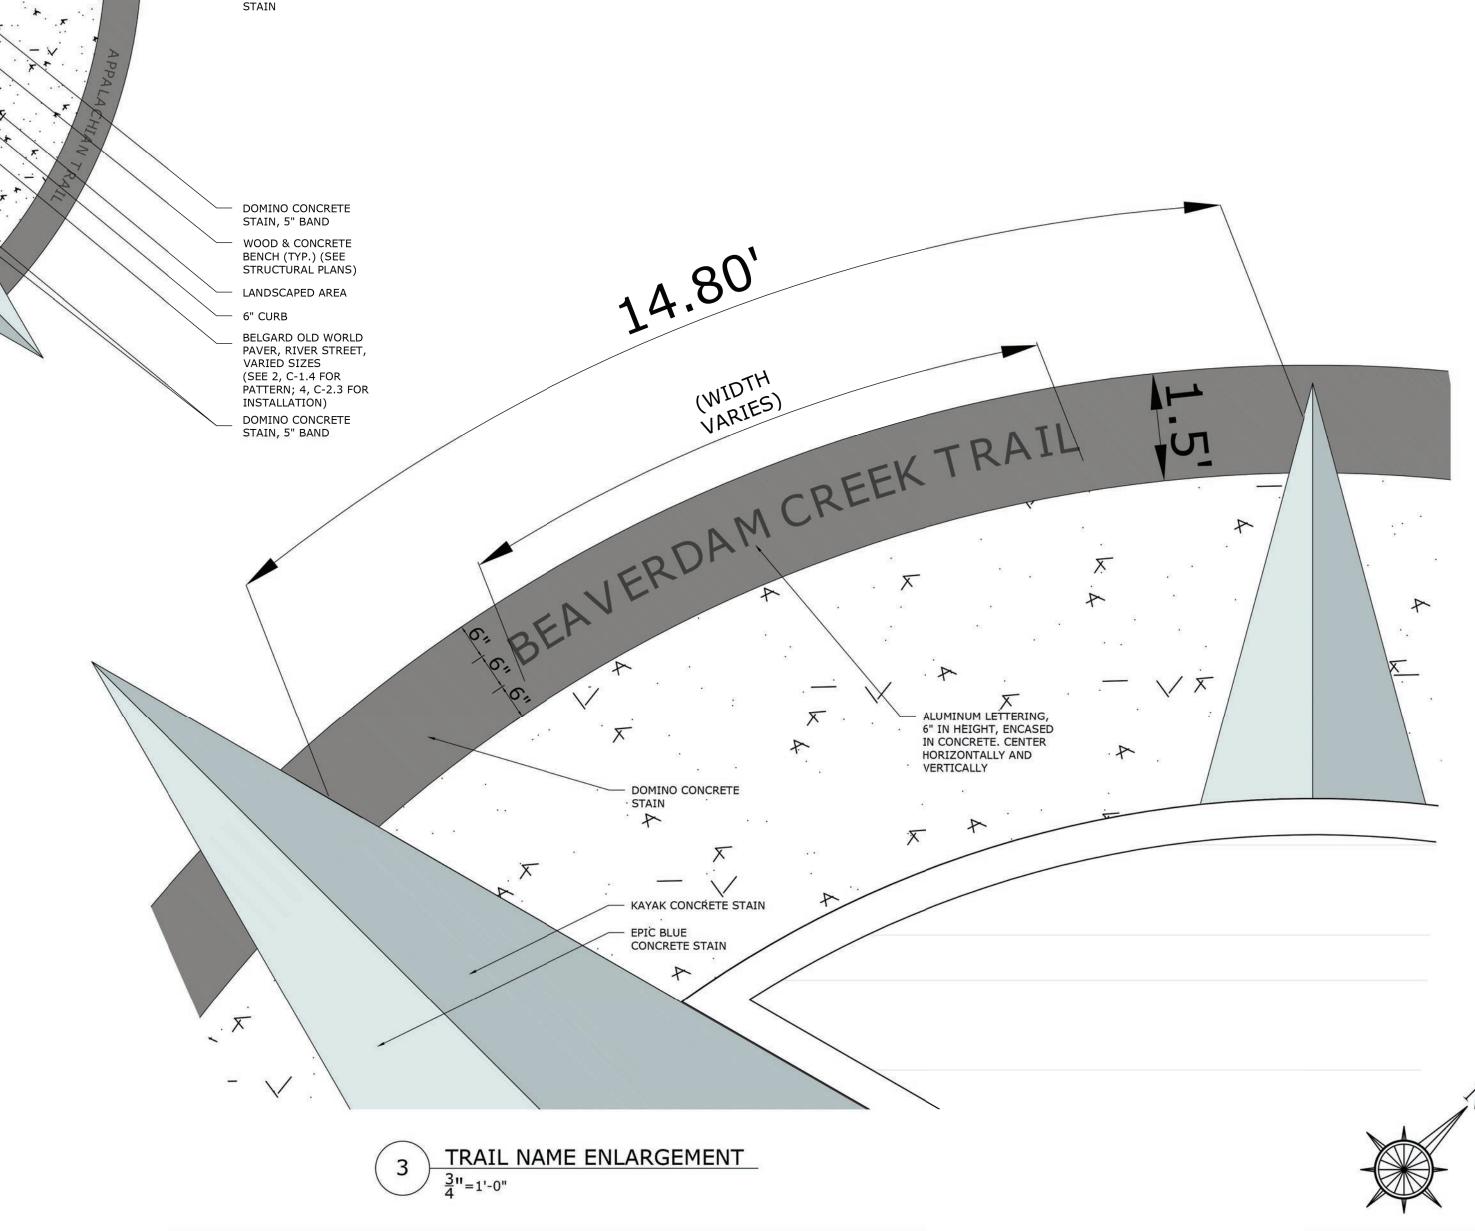

EPIC BLUE CONCRETE STAIN CONCRETE STAIN DOMINO CONCRETE STAIN, ST

TRAIL NAMES:

- 1.) VIRGINIA CREEPER TRAIL
- 2.) IRON MOUNTAIN TRAIL
- 3.) US BIKE 76
- 4.) THE CROOKED ROAD
- 5.) APPALACHIAN TRAIL
- 6.) DANIEL BOONE TRAIL
- 7.) LAUREL CREEK TRAIL
- 8.) BEAVERDAM CREEK TRAIL

LETTERING:

 1.) USE LETRA-TEK MATERIAL OR APPROVED EQUIVALENT
 2.) LETTERING TO BE ¹/₄" THICK ALUMINUM, 6" IN HEIGHT
 3.) TEXT TO BE STYLED AS ACUMIN VARIABLE CONCEPT, EXTRACONDENSED SEMIBOLD, ALL CAPS
 4.) LETTERING TO BE RECESSED IN CONCRETE WITH A FLUSH FINISH
 5.) LETTERING TO BE INSTALLED TO MANUFACTURER'S SPECIFICATIONS




FILE NUMBER:

Know what's below


Call before you dig


9.26.16

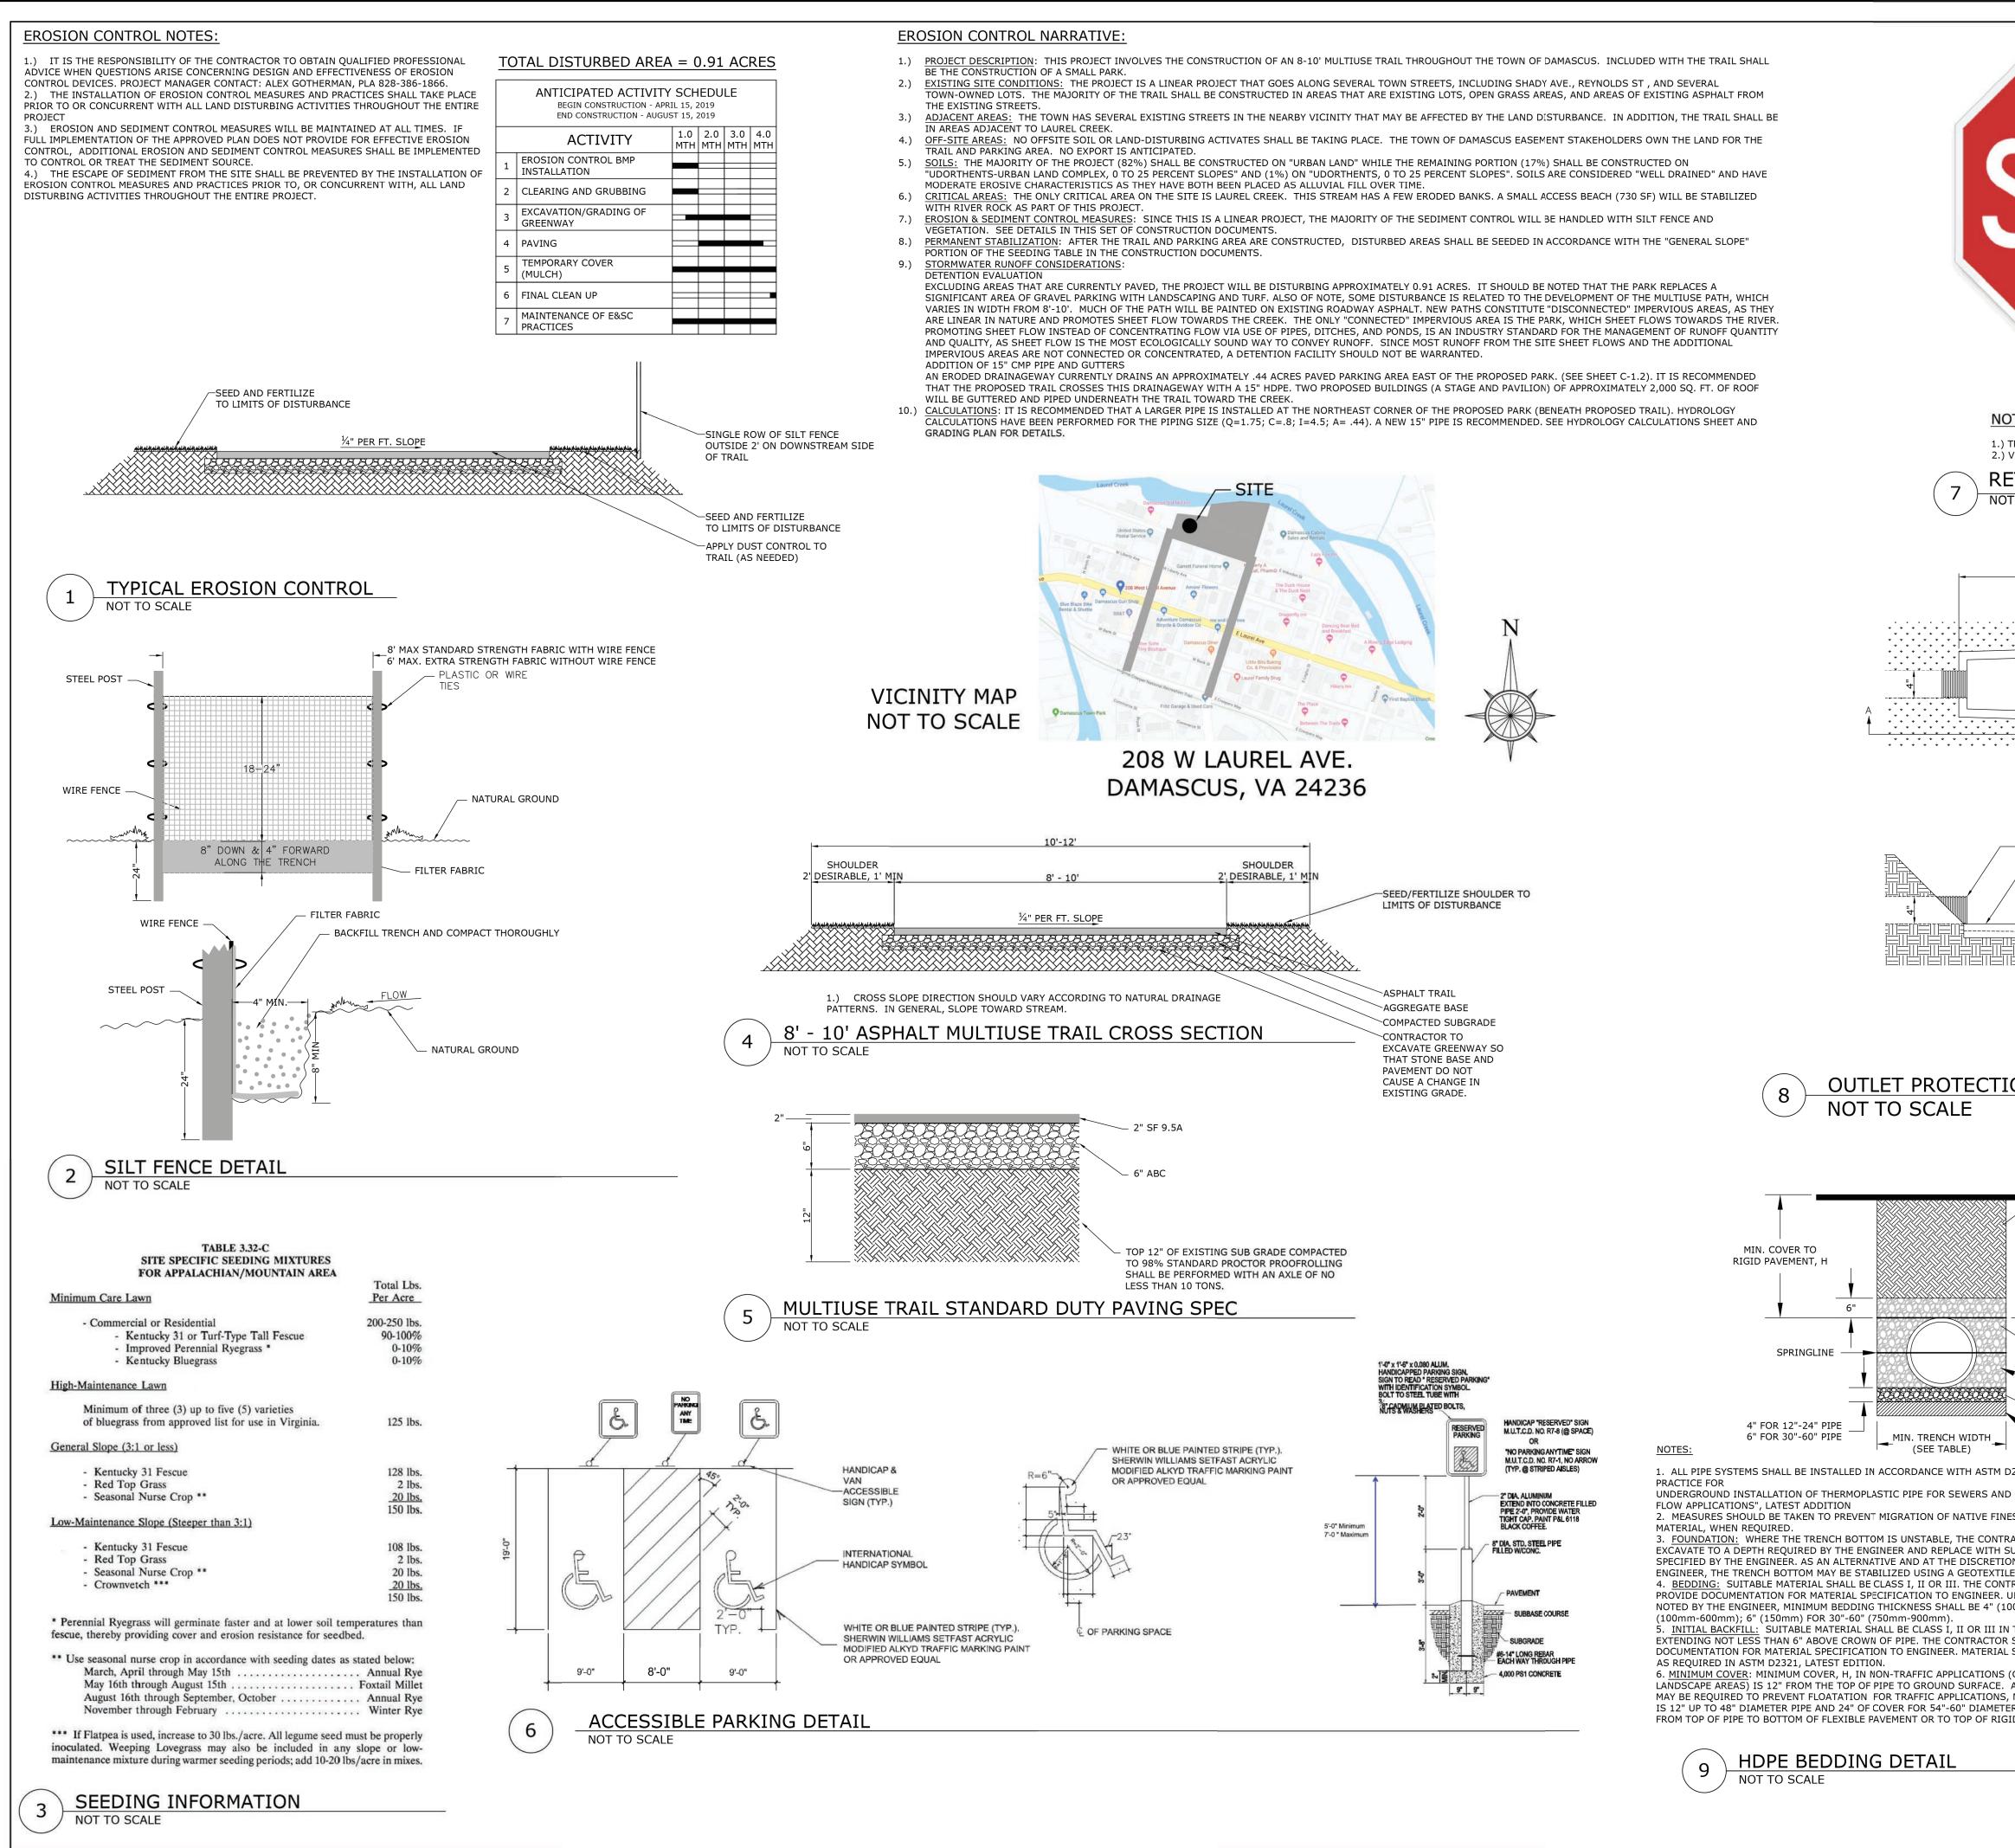


			PROJECT:	
			Laurel C	lreek
			Park and	
STOF				11711
			ADDRESS: 208 W Laure Damascus, VA	
			DEVELOPER:	
				- f
TES: TRAILS STOP SIGNS @ 18 X 18"			Town	
VEHICULAR STOP STOP SIGNS @ 24" X 24" TROREFLECTIVE R1-1 '	'STOP" SIGN	N	Damascu	s, VA
T TO SCALE			DAMA CROSSIN	SCUS G PATHS
2'				ns, Town Manager 103, ext. 315
		-	LANDSCAPE ARCHITECT:	
			DESTINATION	BY DESIGN
PLAN			Destination by Design 1 136 Furman Rd,	
			Boone, NC 28 828-386-18 www.dbdplanning	607 66
	1" 1	DEPTH MIN. FO 2" ER ROCK	SEAL: VA 2102	All Car
SECTION A-A	NOTE: OUTLET PR	OTEXTILE FABRIC ROTECTION SHALL OPE FOR LENGTH OF	Charles A. Gother	r and a second sec
ON FOR 4" ADS PIPE			Charles L. Sol	
			11/22/19	
FINAL			REVISIONS	DATE
MIN. COVER TO	DED MINIMUM TRENCH W	-	1 WACO COMMENTS 2 VDOT COMMENTS	<u> 10/02/1</u> 10/03/1
FLEXIBLE PAVEMENT, H 4"	21"	-		
8"	26" 28"	_		
INITIAL 12" BACKFILL 15"		-		
HAUNCH 18"	39"	-		
BEDDING 24" SUITABLE 30"		-		
FOUNDATION 36"		-		
2321, "STANDARD	80"	_	PROJECT MANAGER:	CA
S INTO BACKFILL 54"		-	DRAWING BY:	
ACTOR SHALL UITABLE MATERIAL AS IN OF THE DESIGN			JURISDICTION: WA	SHINGTON COUNT 11/22/1
E MATERIAL. RACTOR SHALL JNLESS OTHERWISE MINIMUM RECOMME	NDED COVER BASED ON	LOADING CONDITIONS	SHEET TITLE:	
D0mm) FOR 4"-24" THE PIPE ZONE PIPE DIAM.		CONSTRUCTION		
SHALL PROVIDE SHALL BE INSTALLED 12" - 48"	12"	48"	CONSTRUCTION	NOTES 8
GRASS OR 54" - 60" ADDITIONAL COVER * VEHICLES IN EX MINIMUM COVER, H, COVER	24" CESS OF 75T MAY REQUI	60" RE ADDITIONAL	SHEET NUMBER:	
R PIPE, MEASURED D PAVEMENT.				C-2
			SCALE: NTS	
		Know what's below Call before you dig	FILE NUMBER:	9.26.1

NC

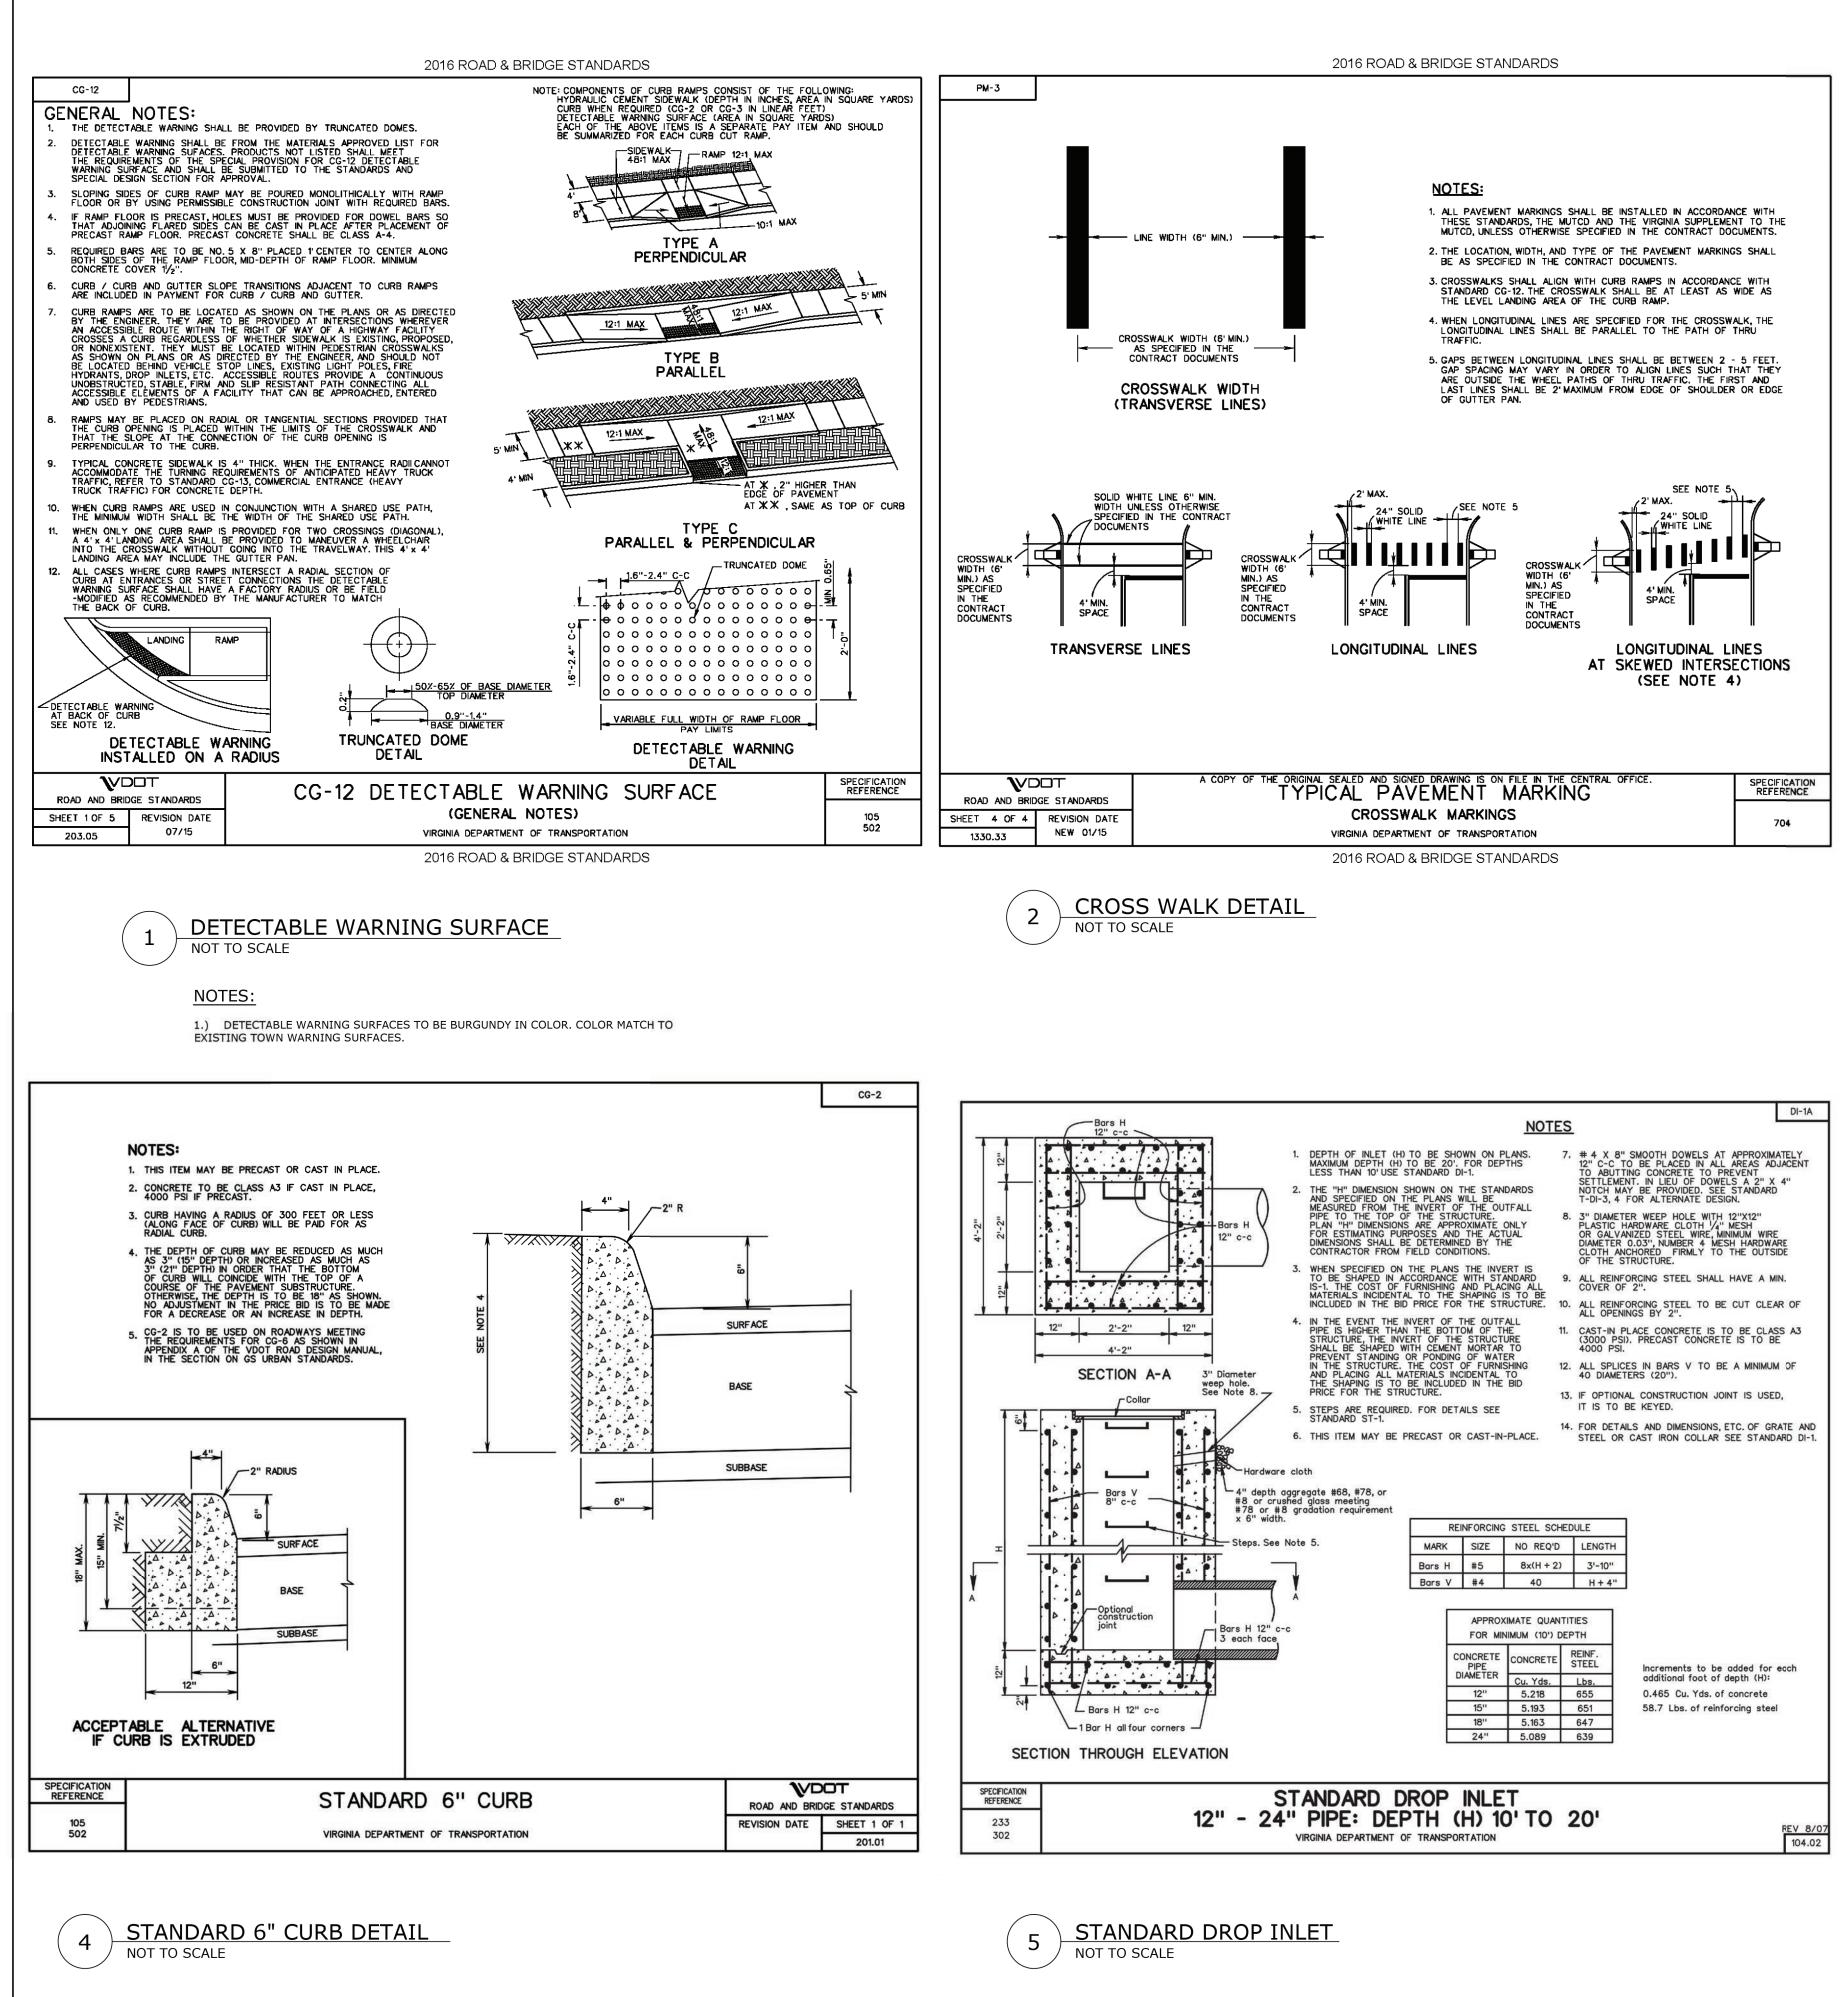

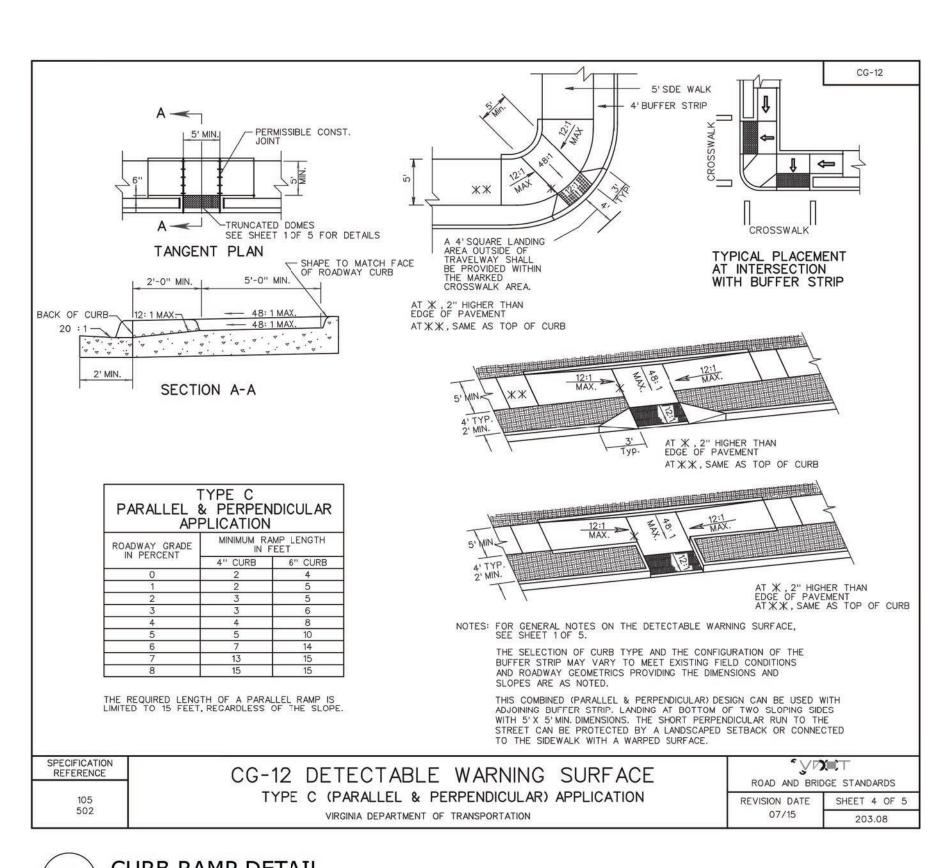




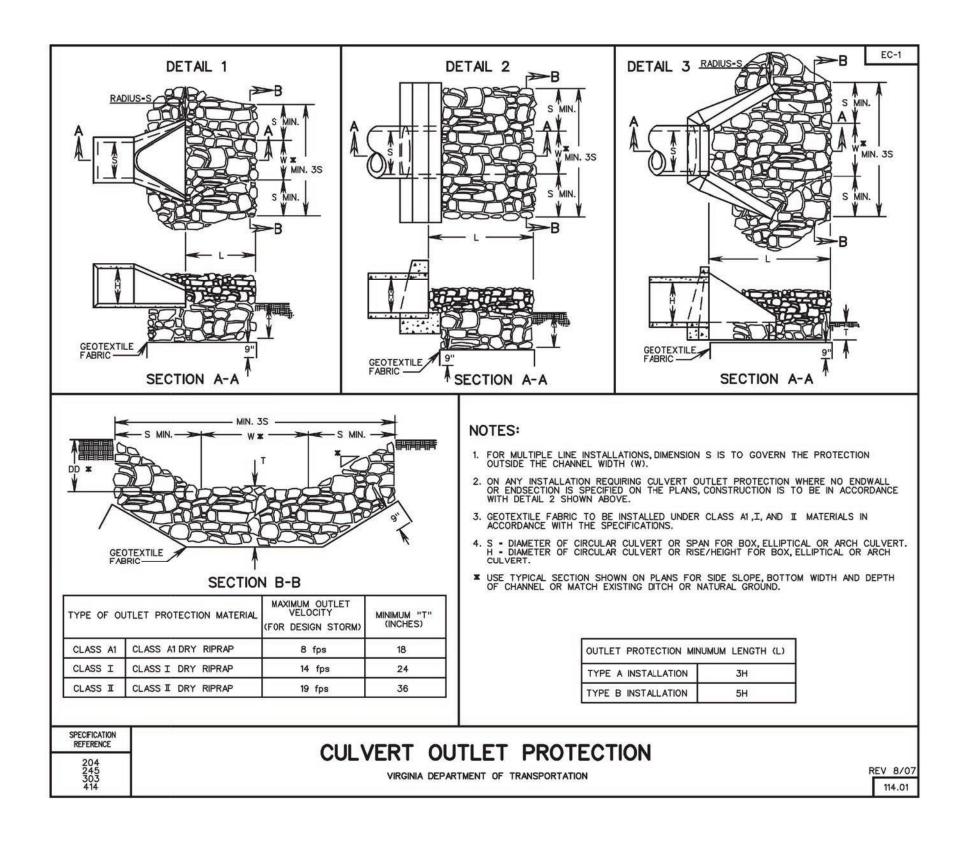

CULVERT OUTLET PROTECTION 6 NOT TO SCALE





Know what's below Call before you dig

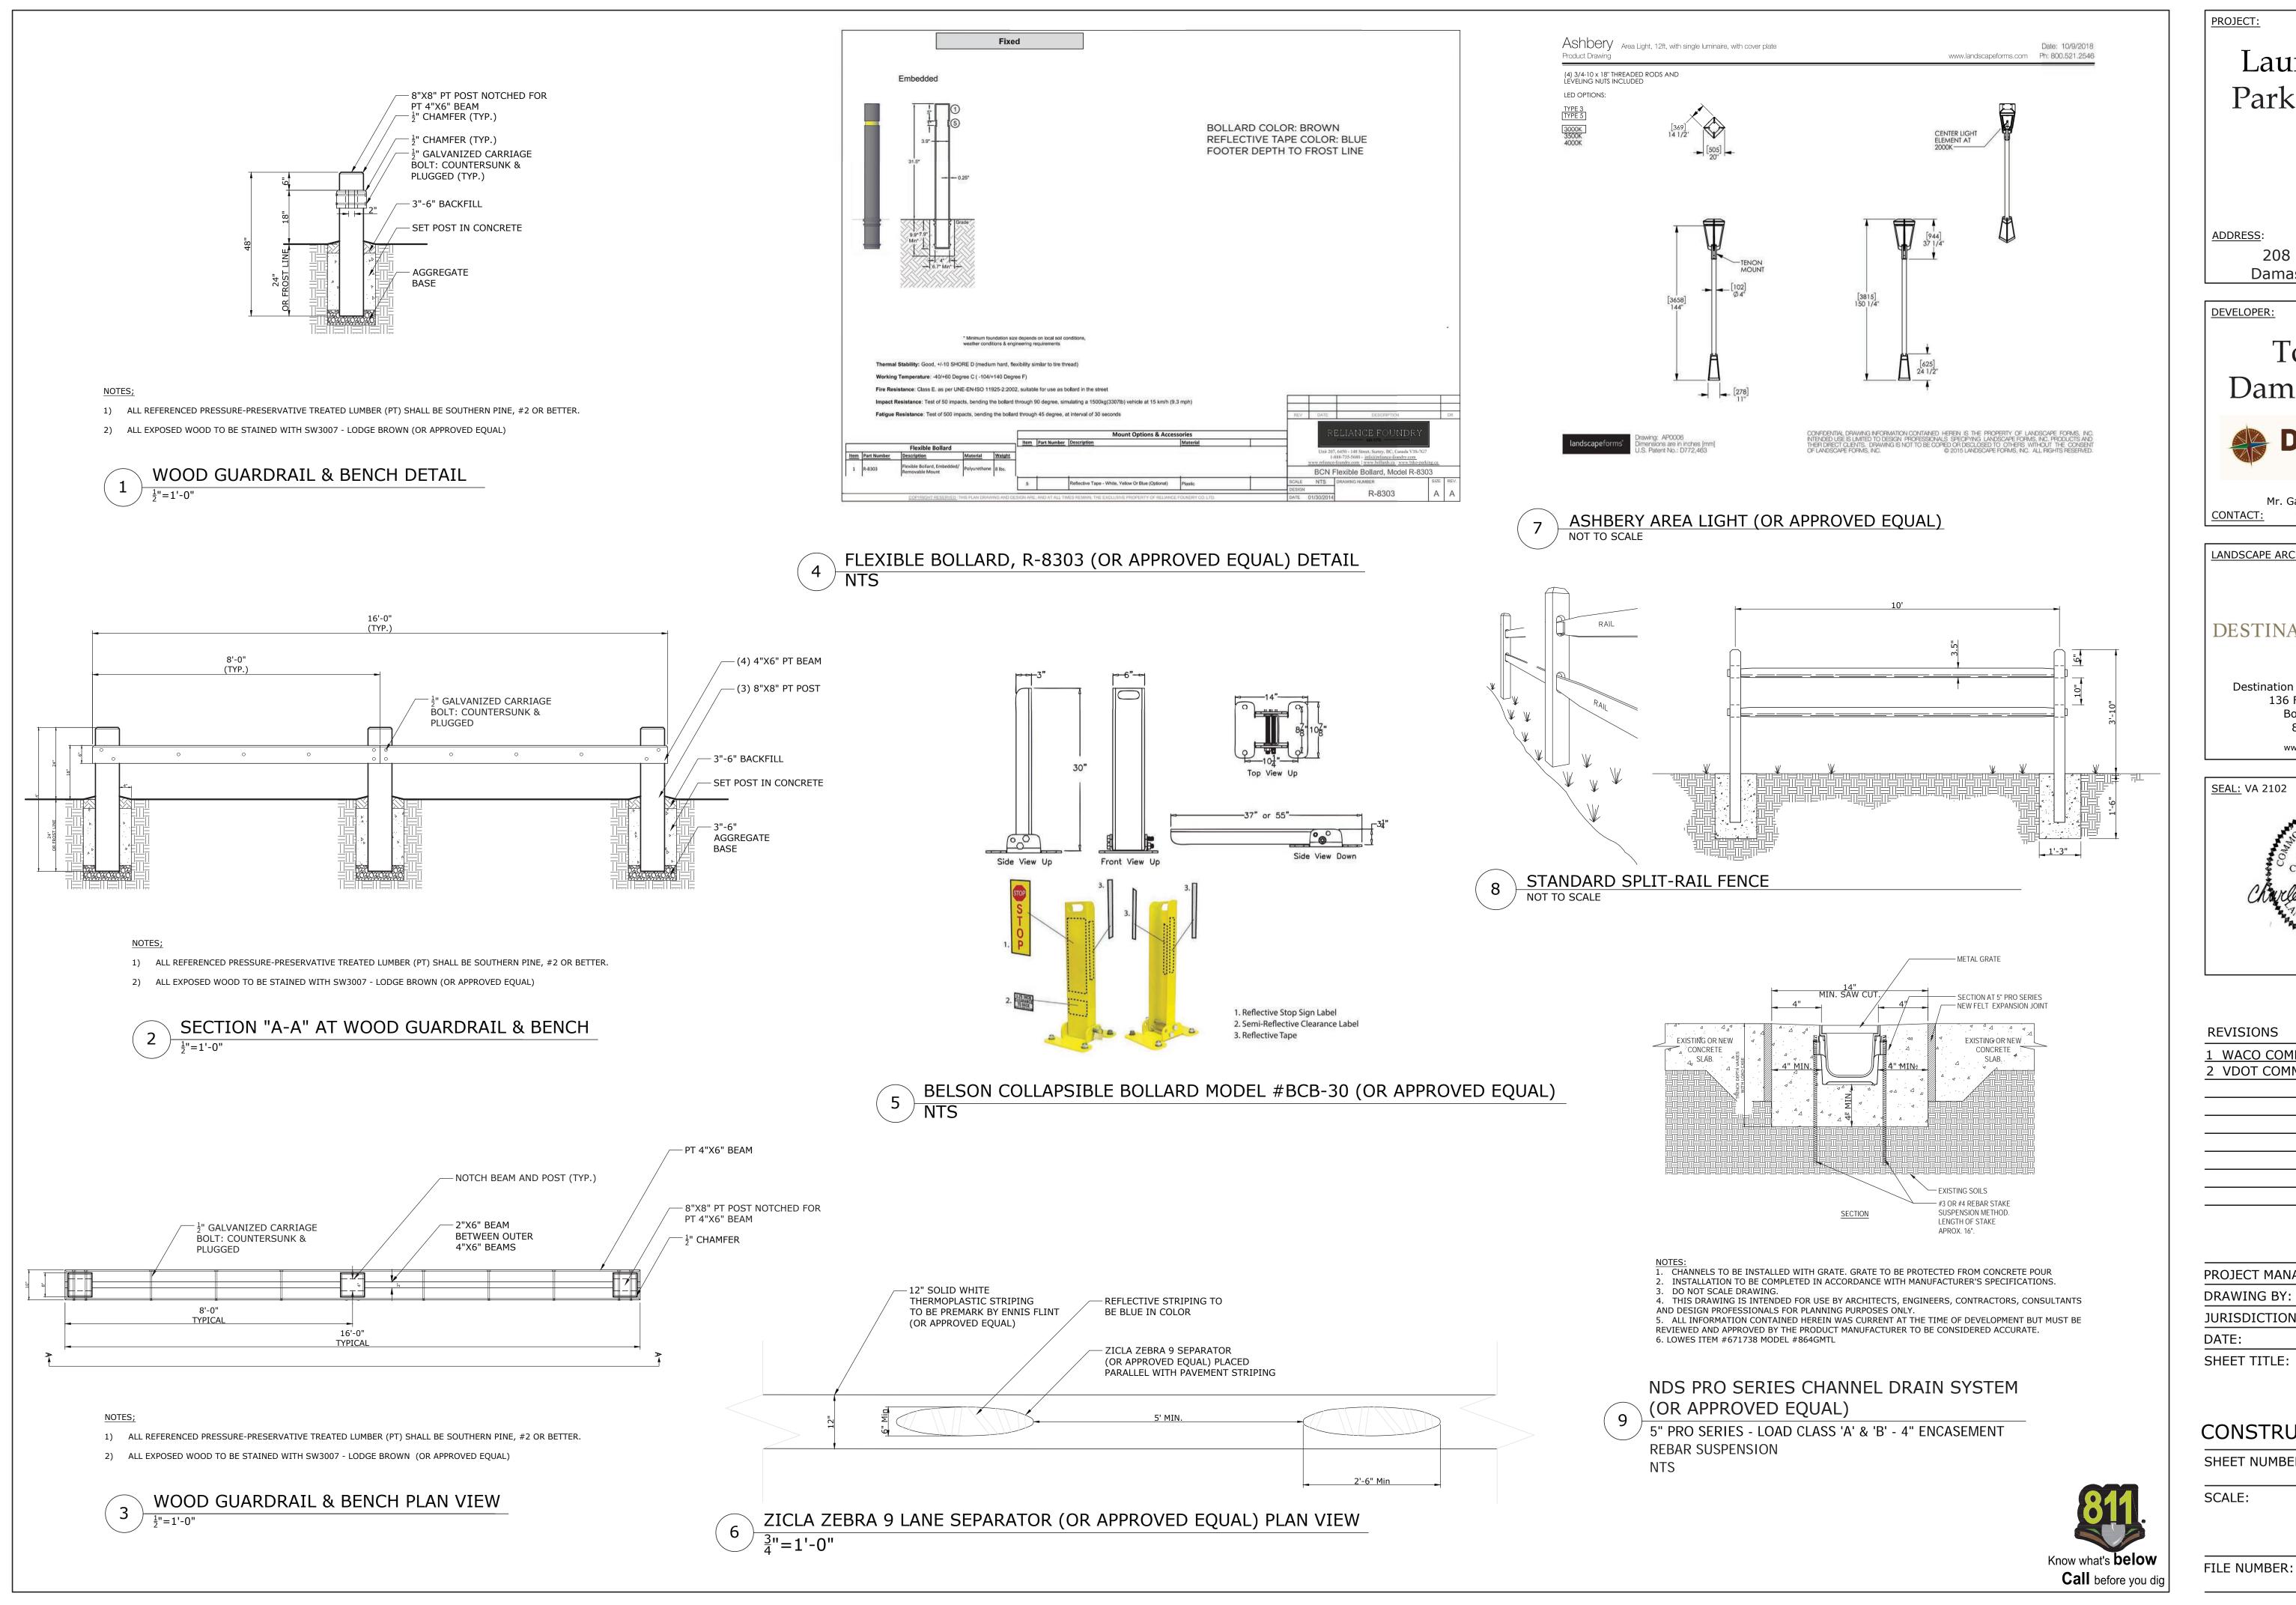


PROJECT:
Laurel Creek
Park and Trail
Fark and Iran
ADDRESS:
208 W Laurel Ave.
Damascus, VA 24236
DEVELOPER:
Town of
Damascus, VA
CROSSING PATHS
Mr. Covin N. Plavina, Taura Maragar
Mr. Gavin N. Blevins, Town Manager <u>CONTACT:</u> (276)783-5103, ext. 315
LANDSCAPE ARCHITECT:
DESTINATION BY DESIGN
studios
Destination by Design Studios, PLLC
136 Furman Rd, Ste. 6
Boone, NC 28607 828-386-1866
www.dbdplanning.com
<u>SEAL:</u> VA 2102
SLAL. VA 2102
NONWEALTH OF LIR
Charles A. Gotherman
Charles L. Stherman
Churcles L. Sthorman
CAPE ARCHING
11/22/19
REVISIONS DATE
<u>1 WACO COMMENTS 10/02/19</u>
2 VDOT COMMENTS 10/03/19
PROJECT MANAGER: CAG
DRAWING BY: DAD
JURISDICTION: WASHINGTON COUNTY
DATE: 11/22/19
SHEET TITLE:
NOTES &
CONSTRUCTION DETAILS
C-2.2
SCALE: NTS


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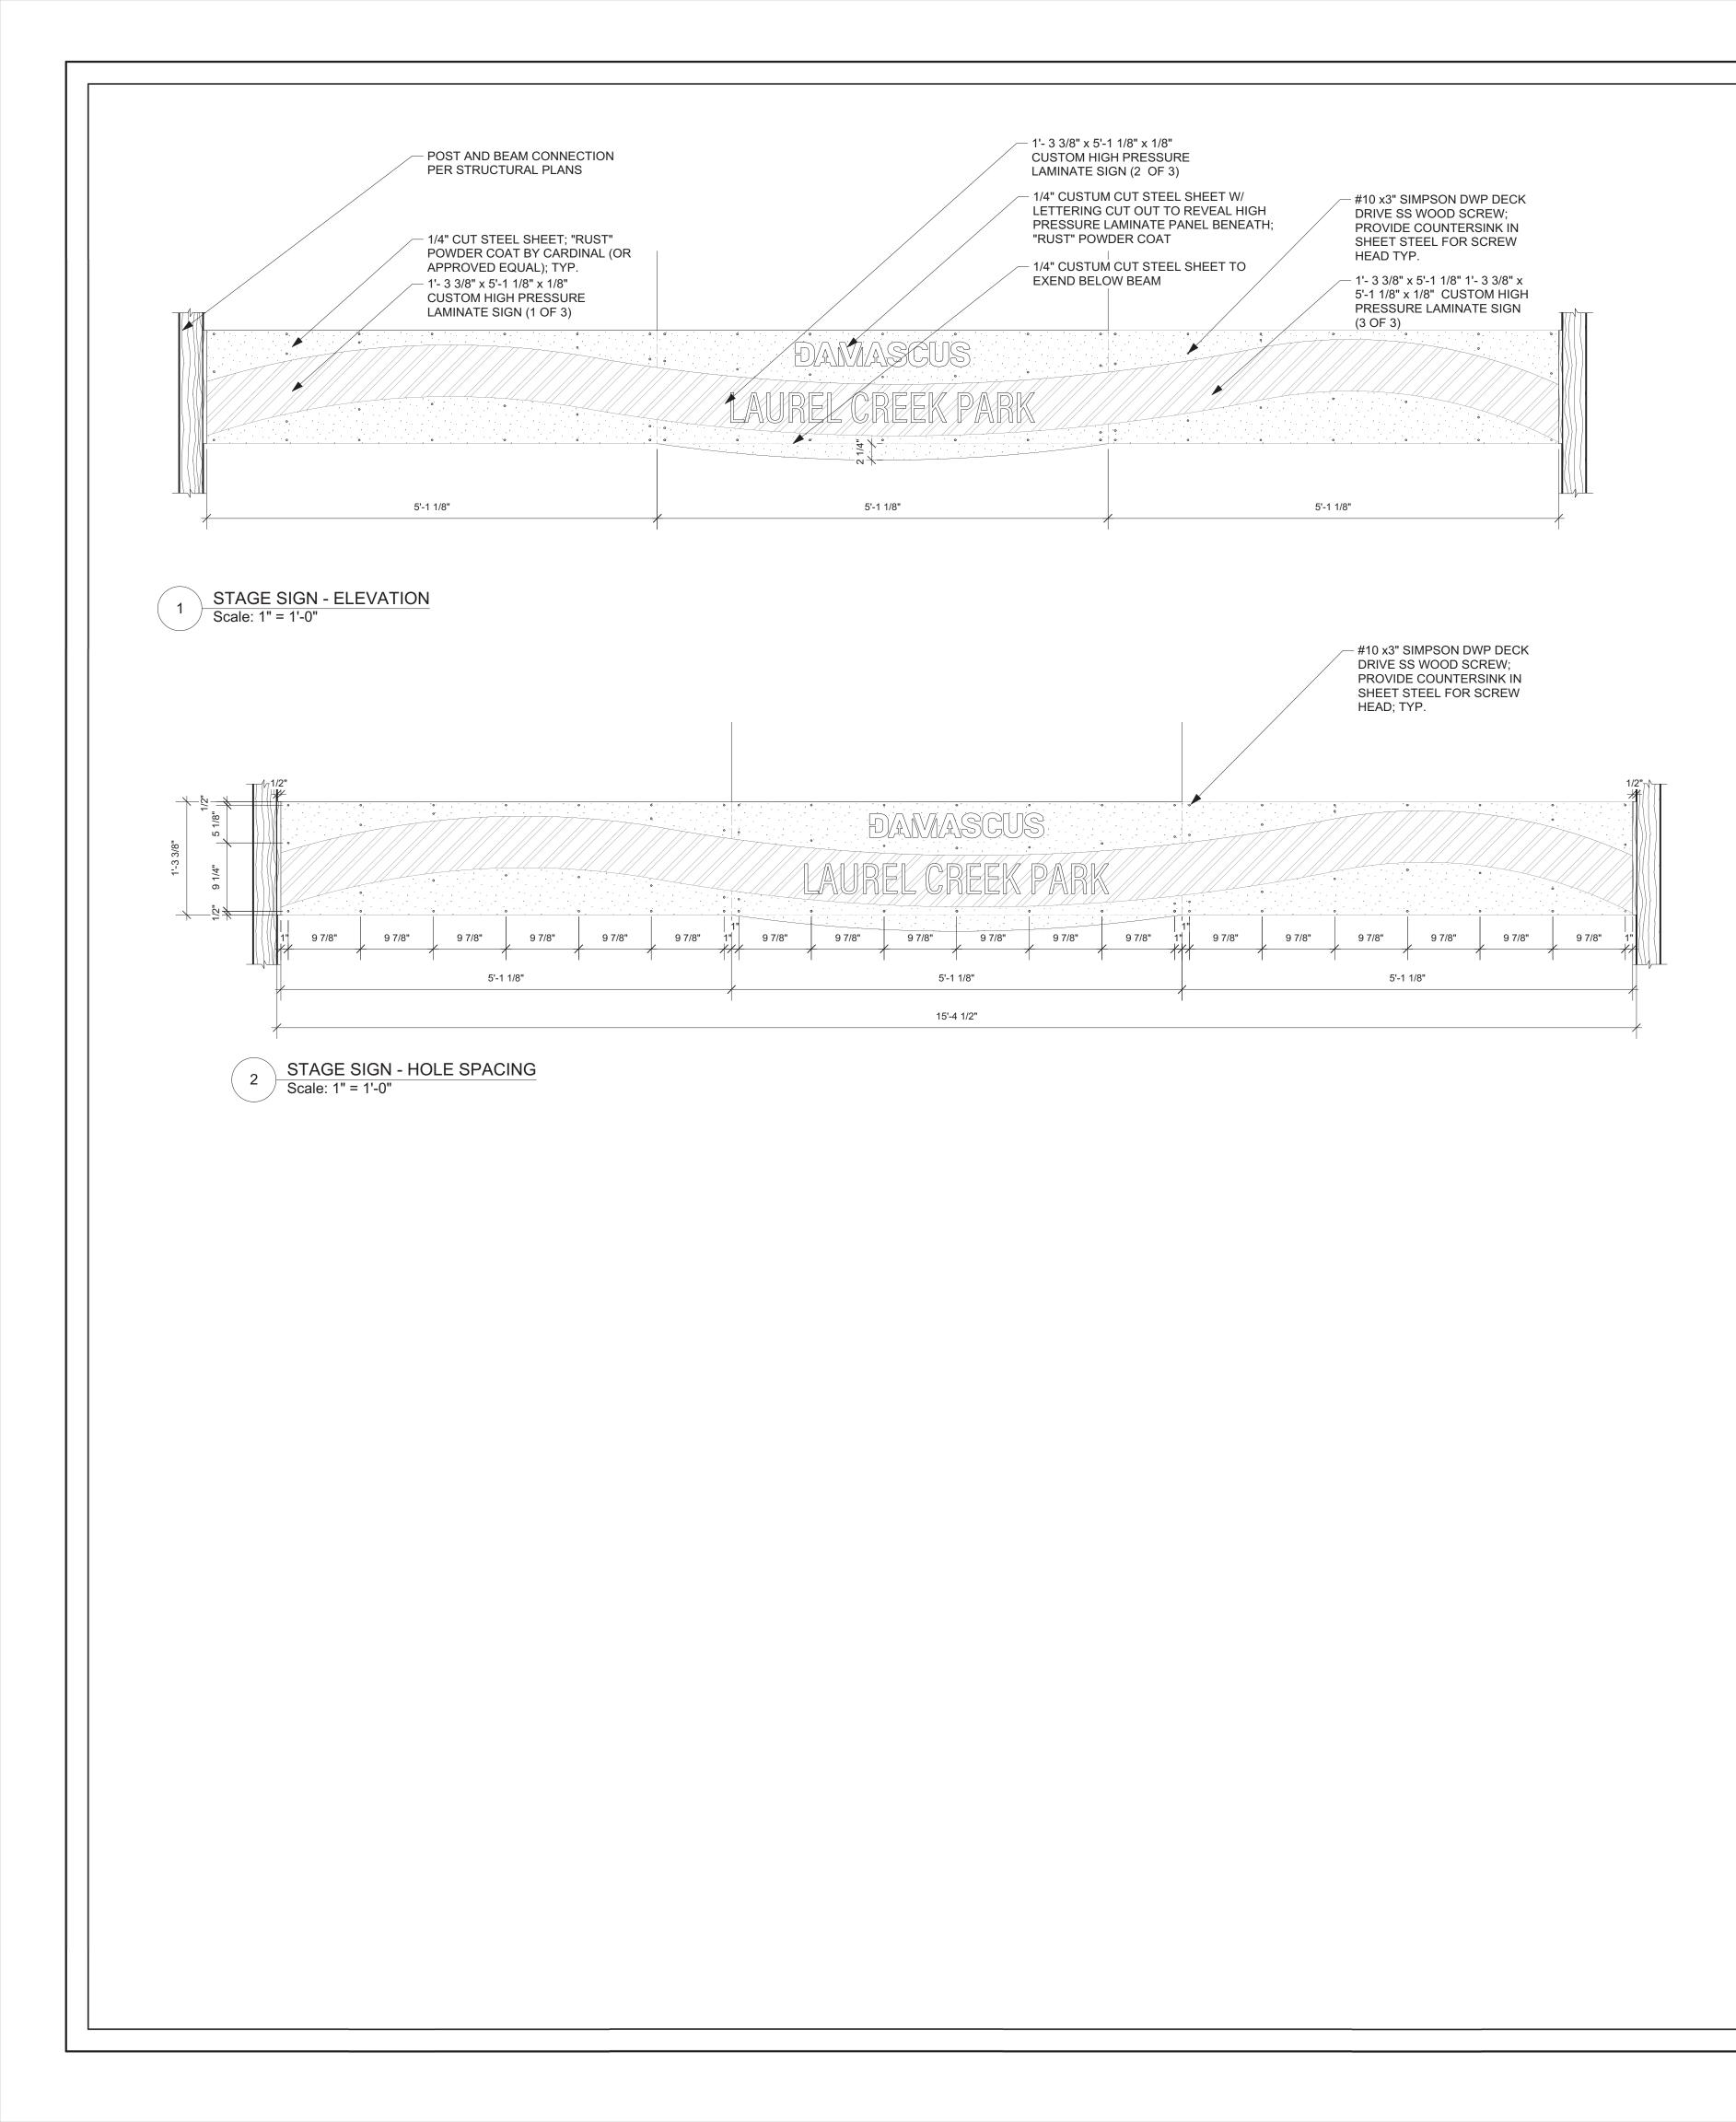


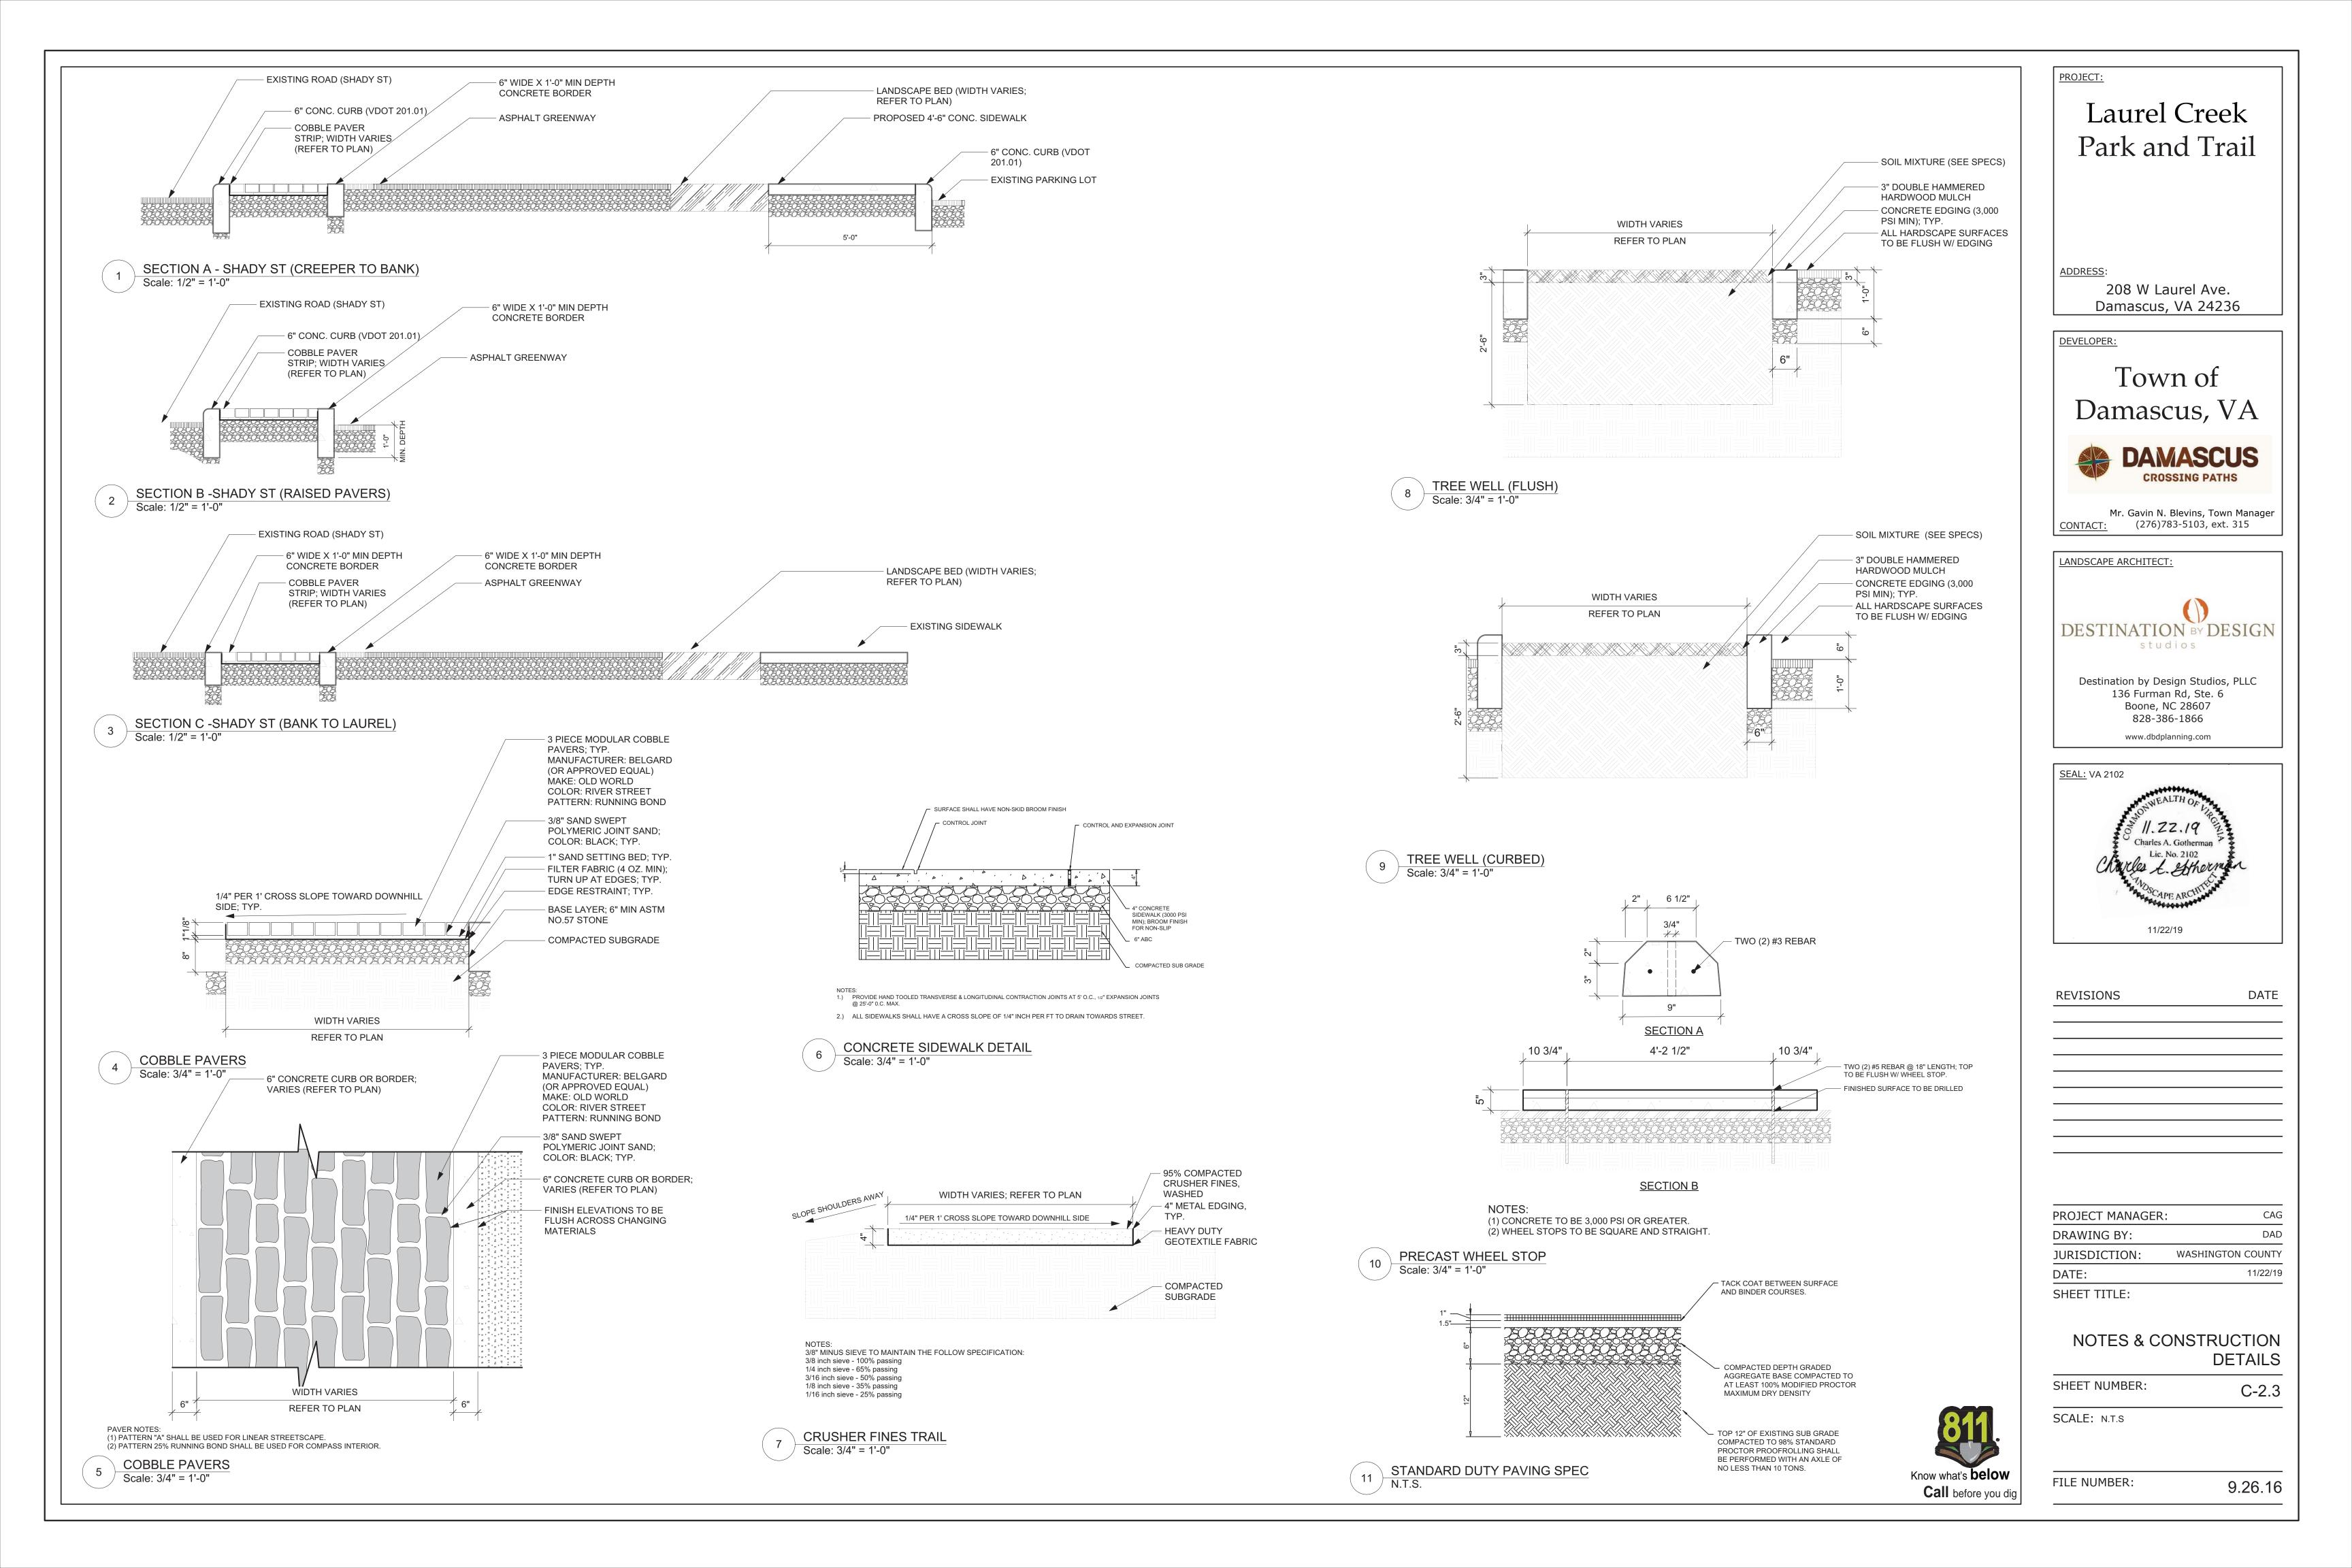

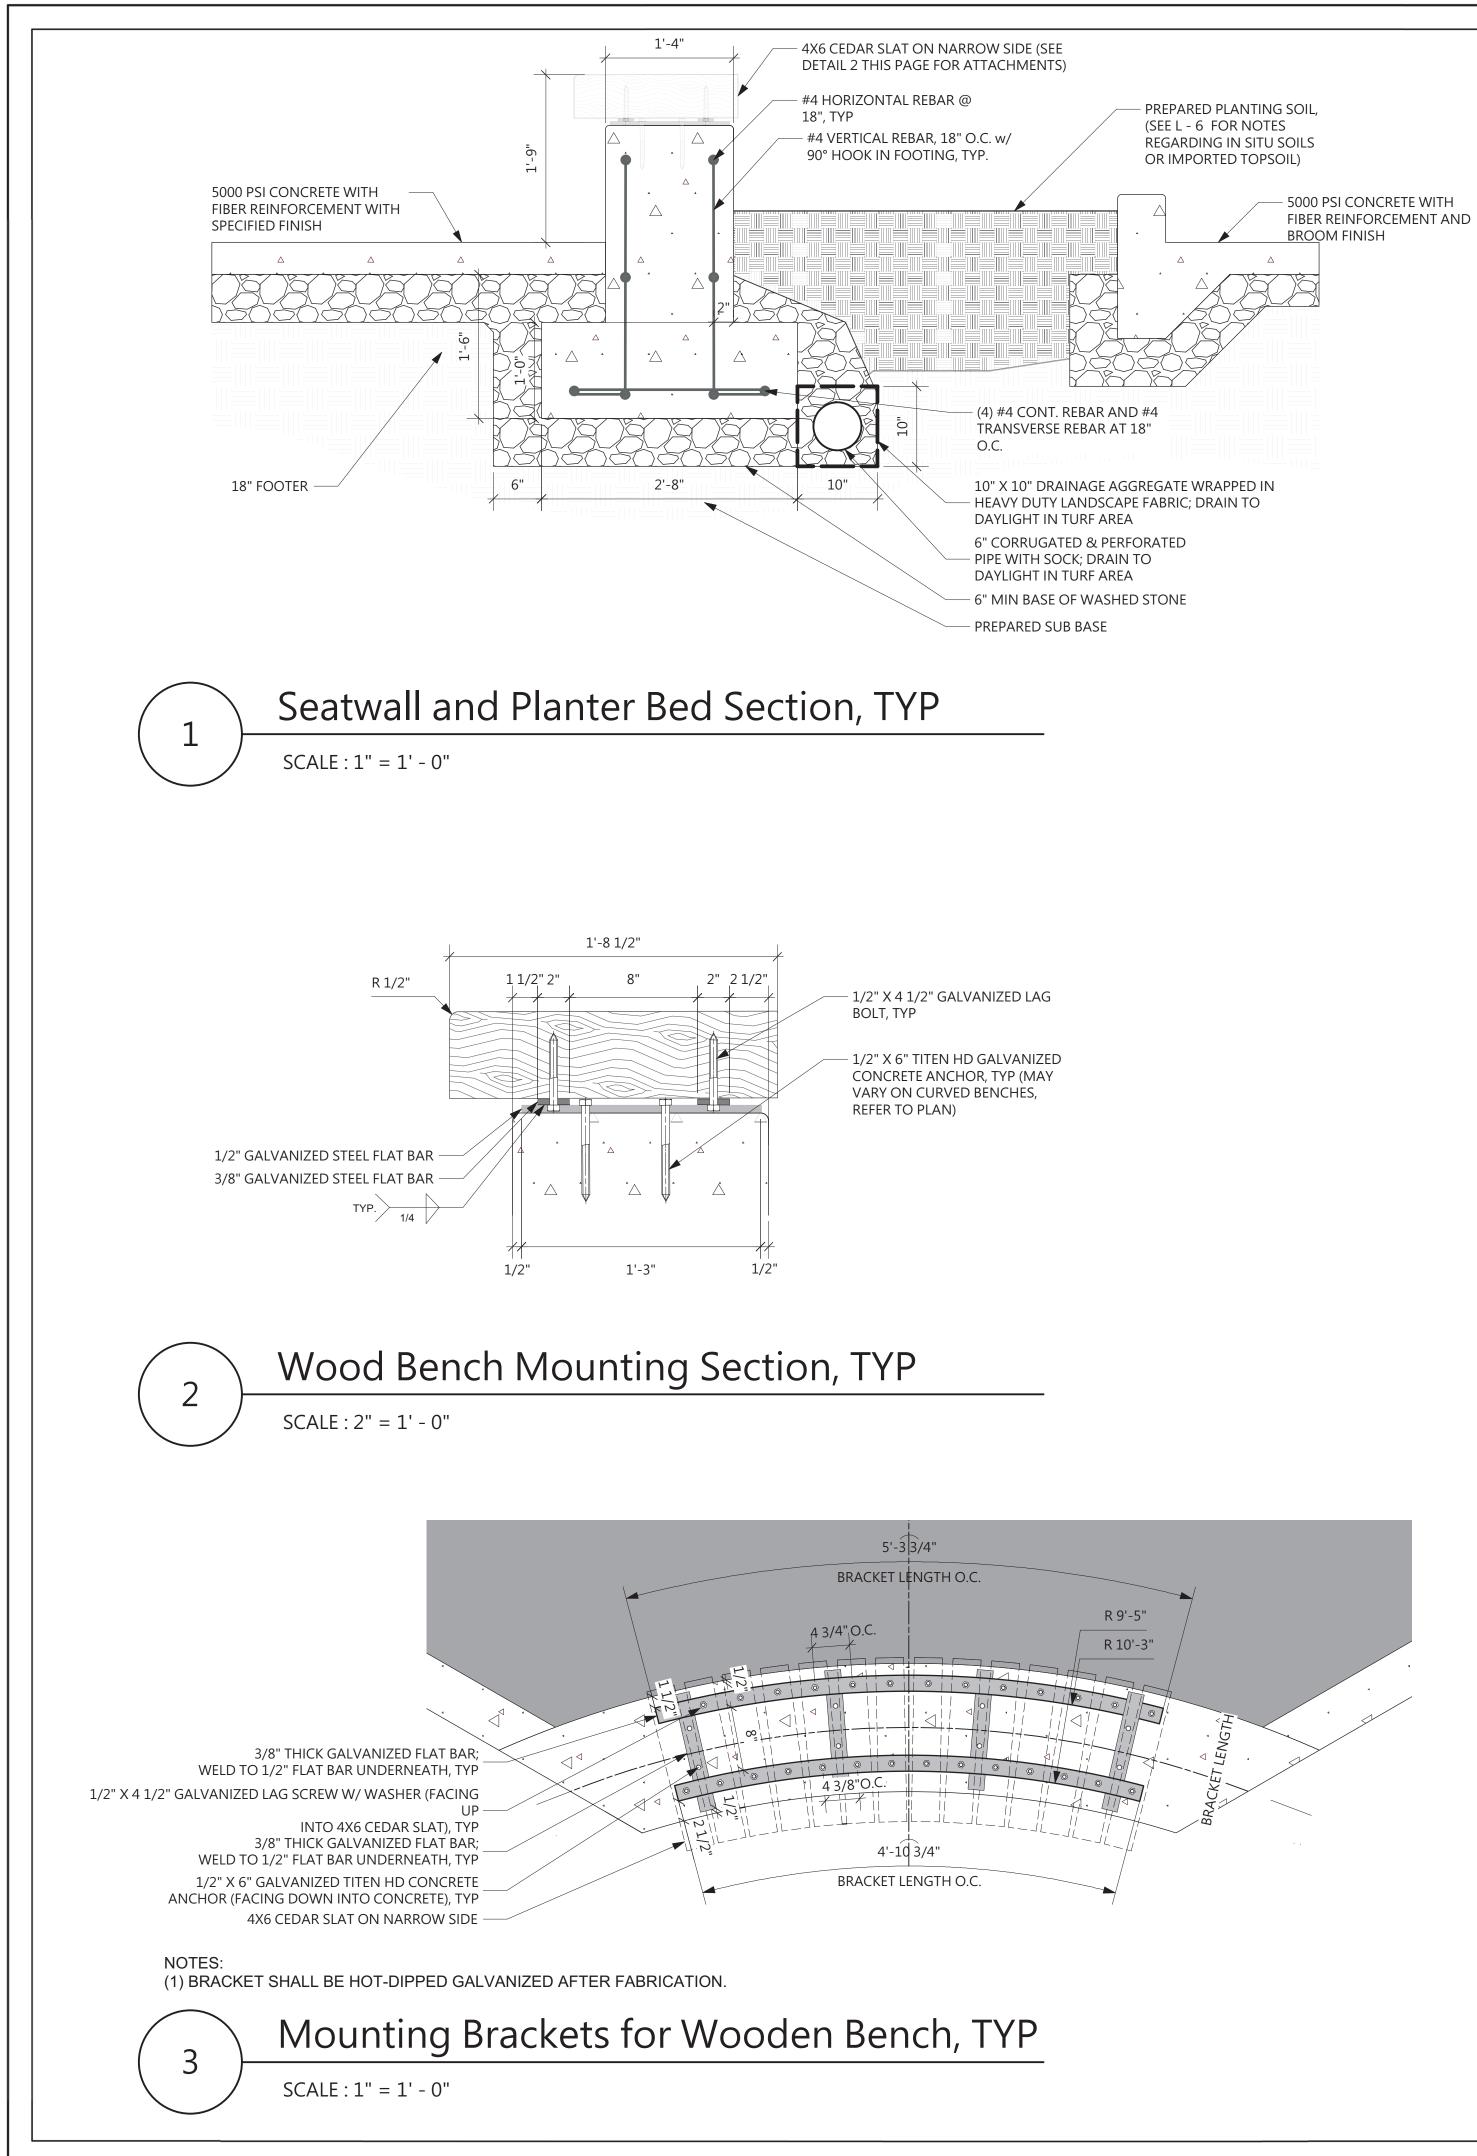

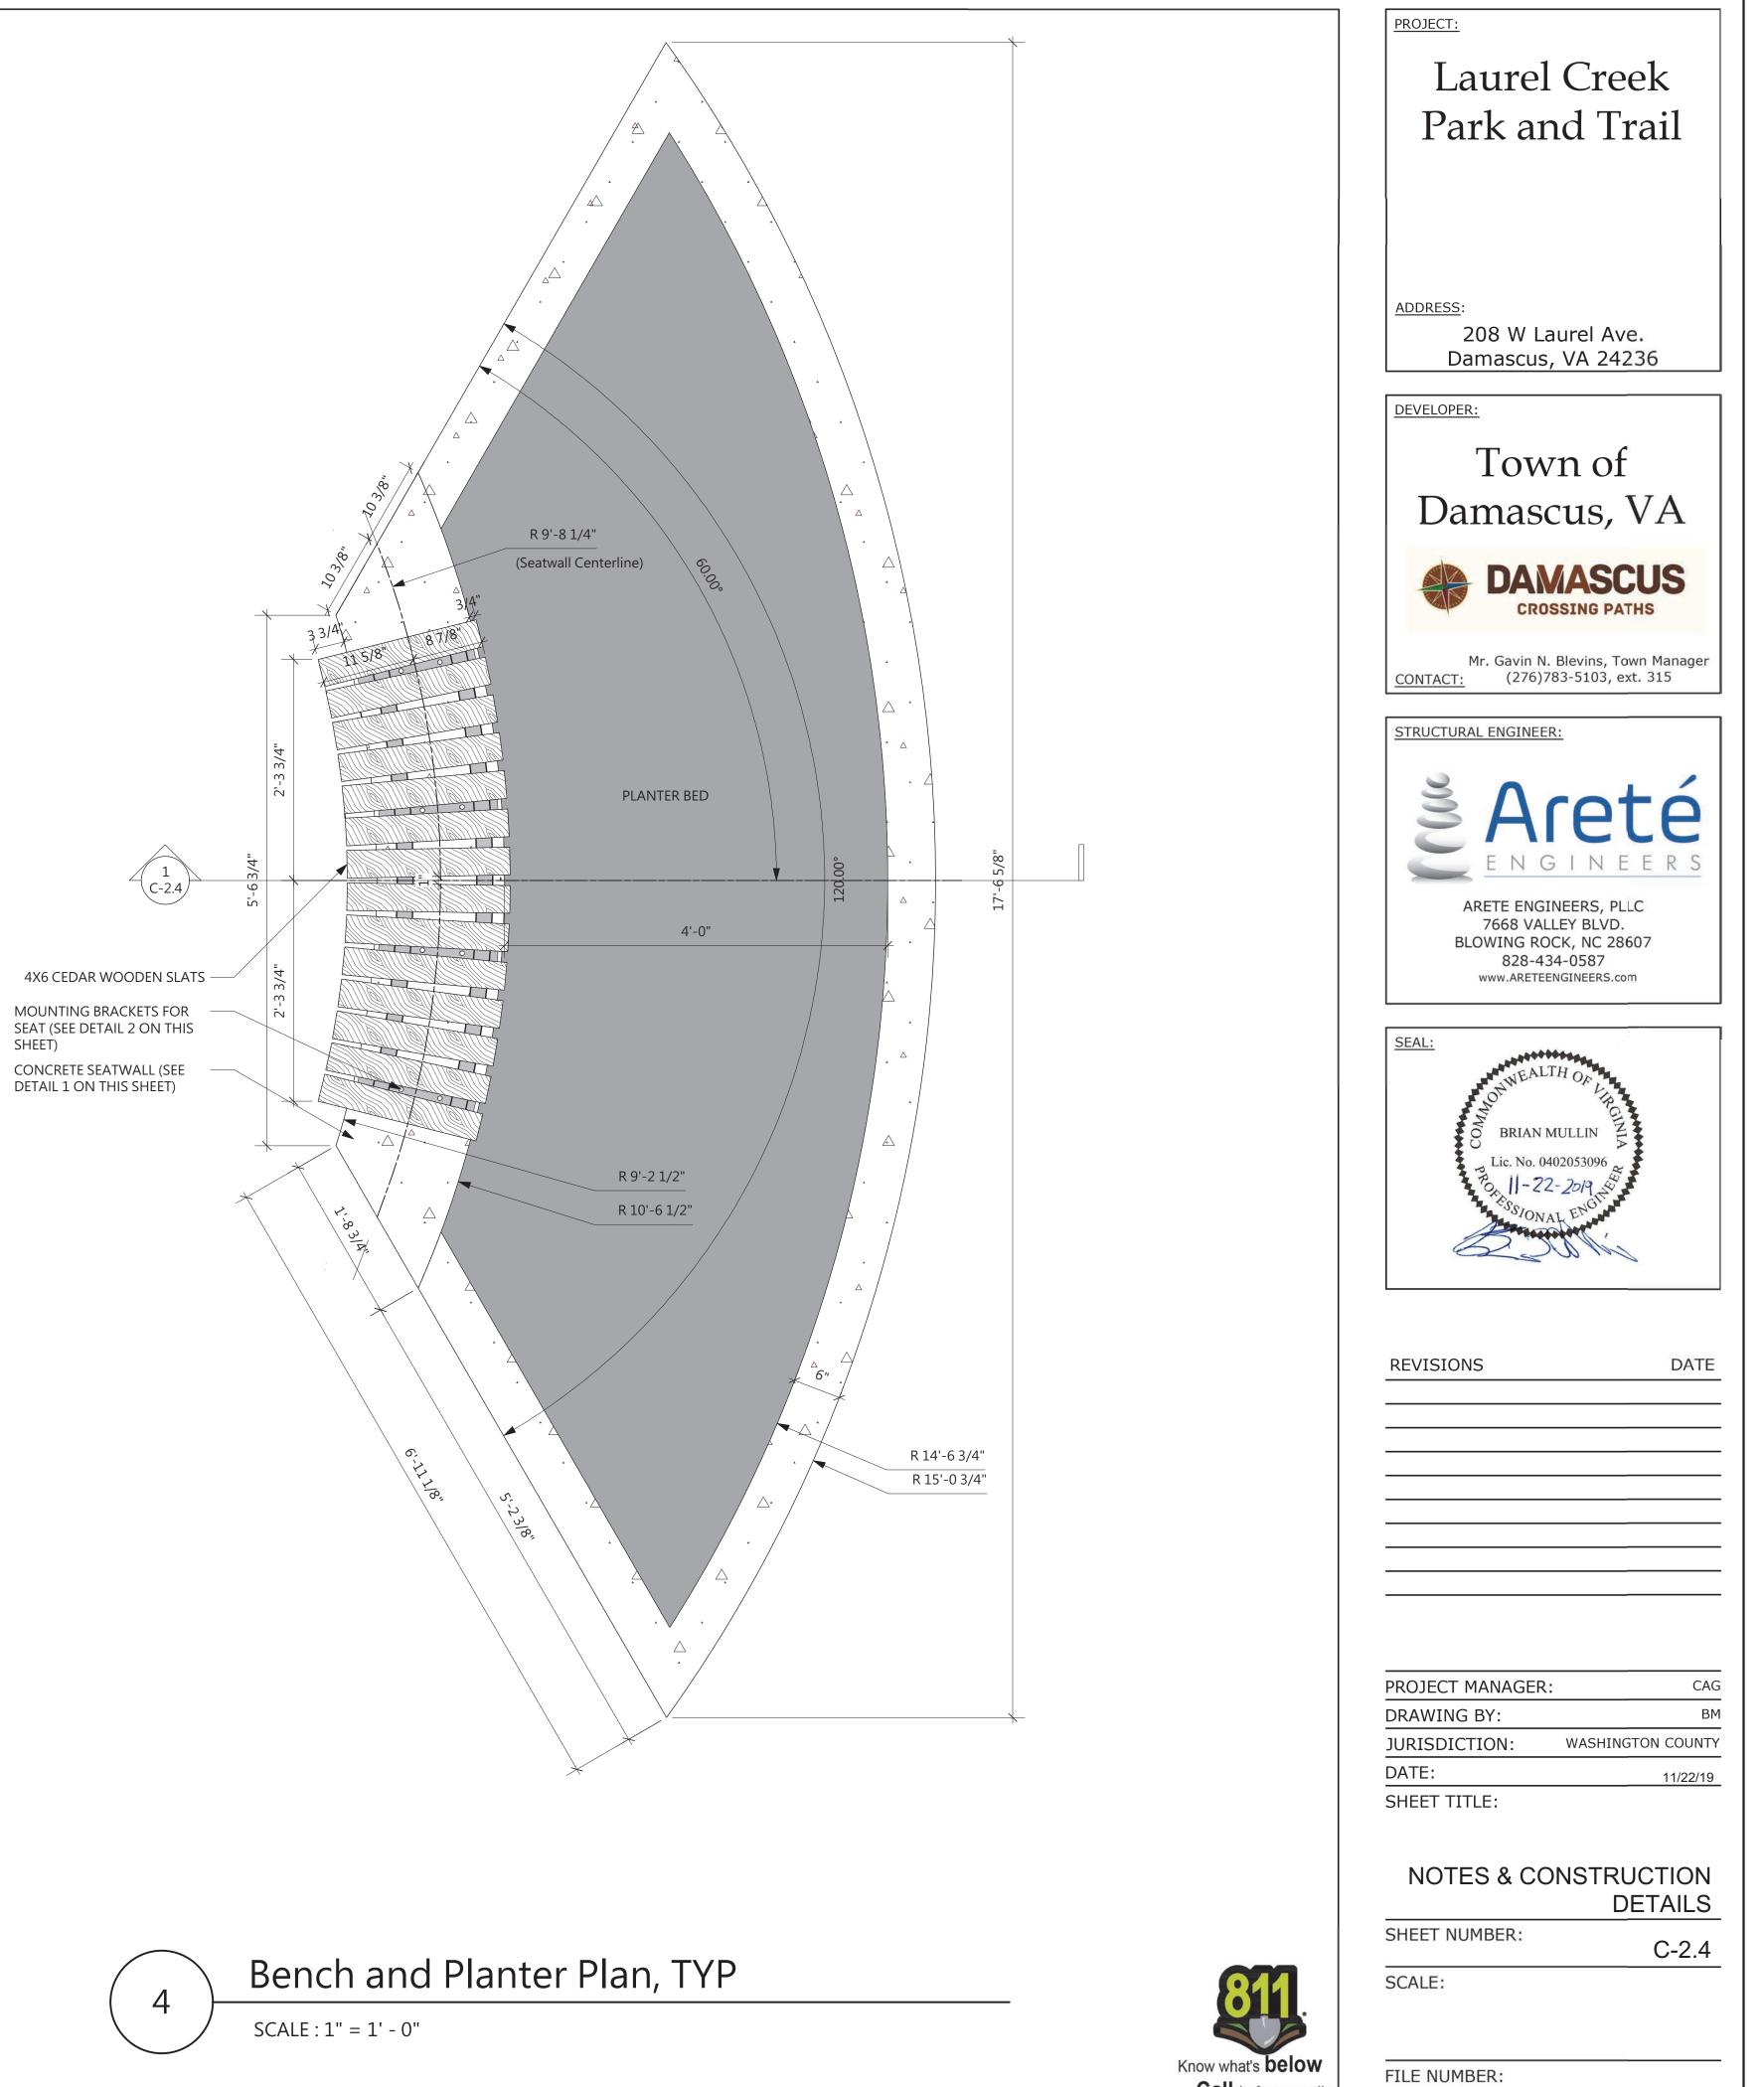Call before you dig



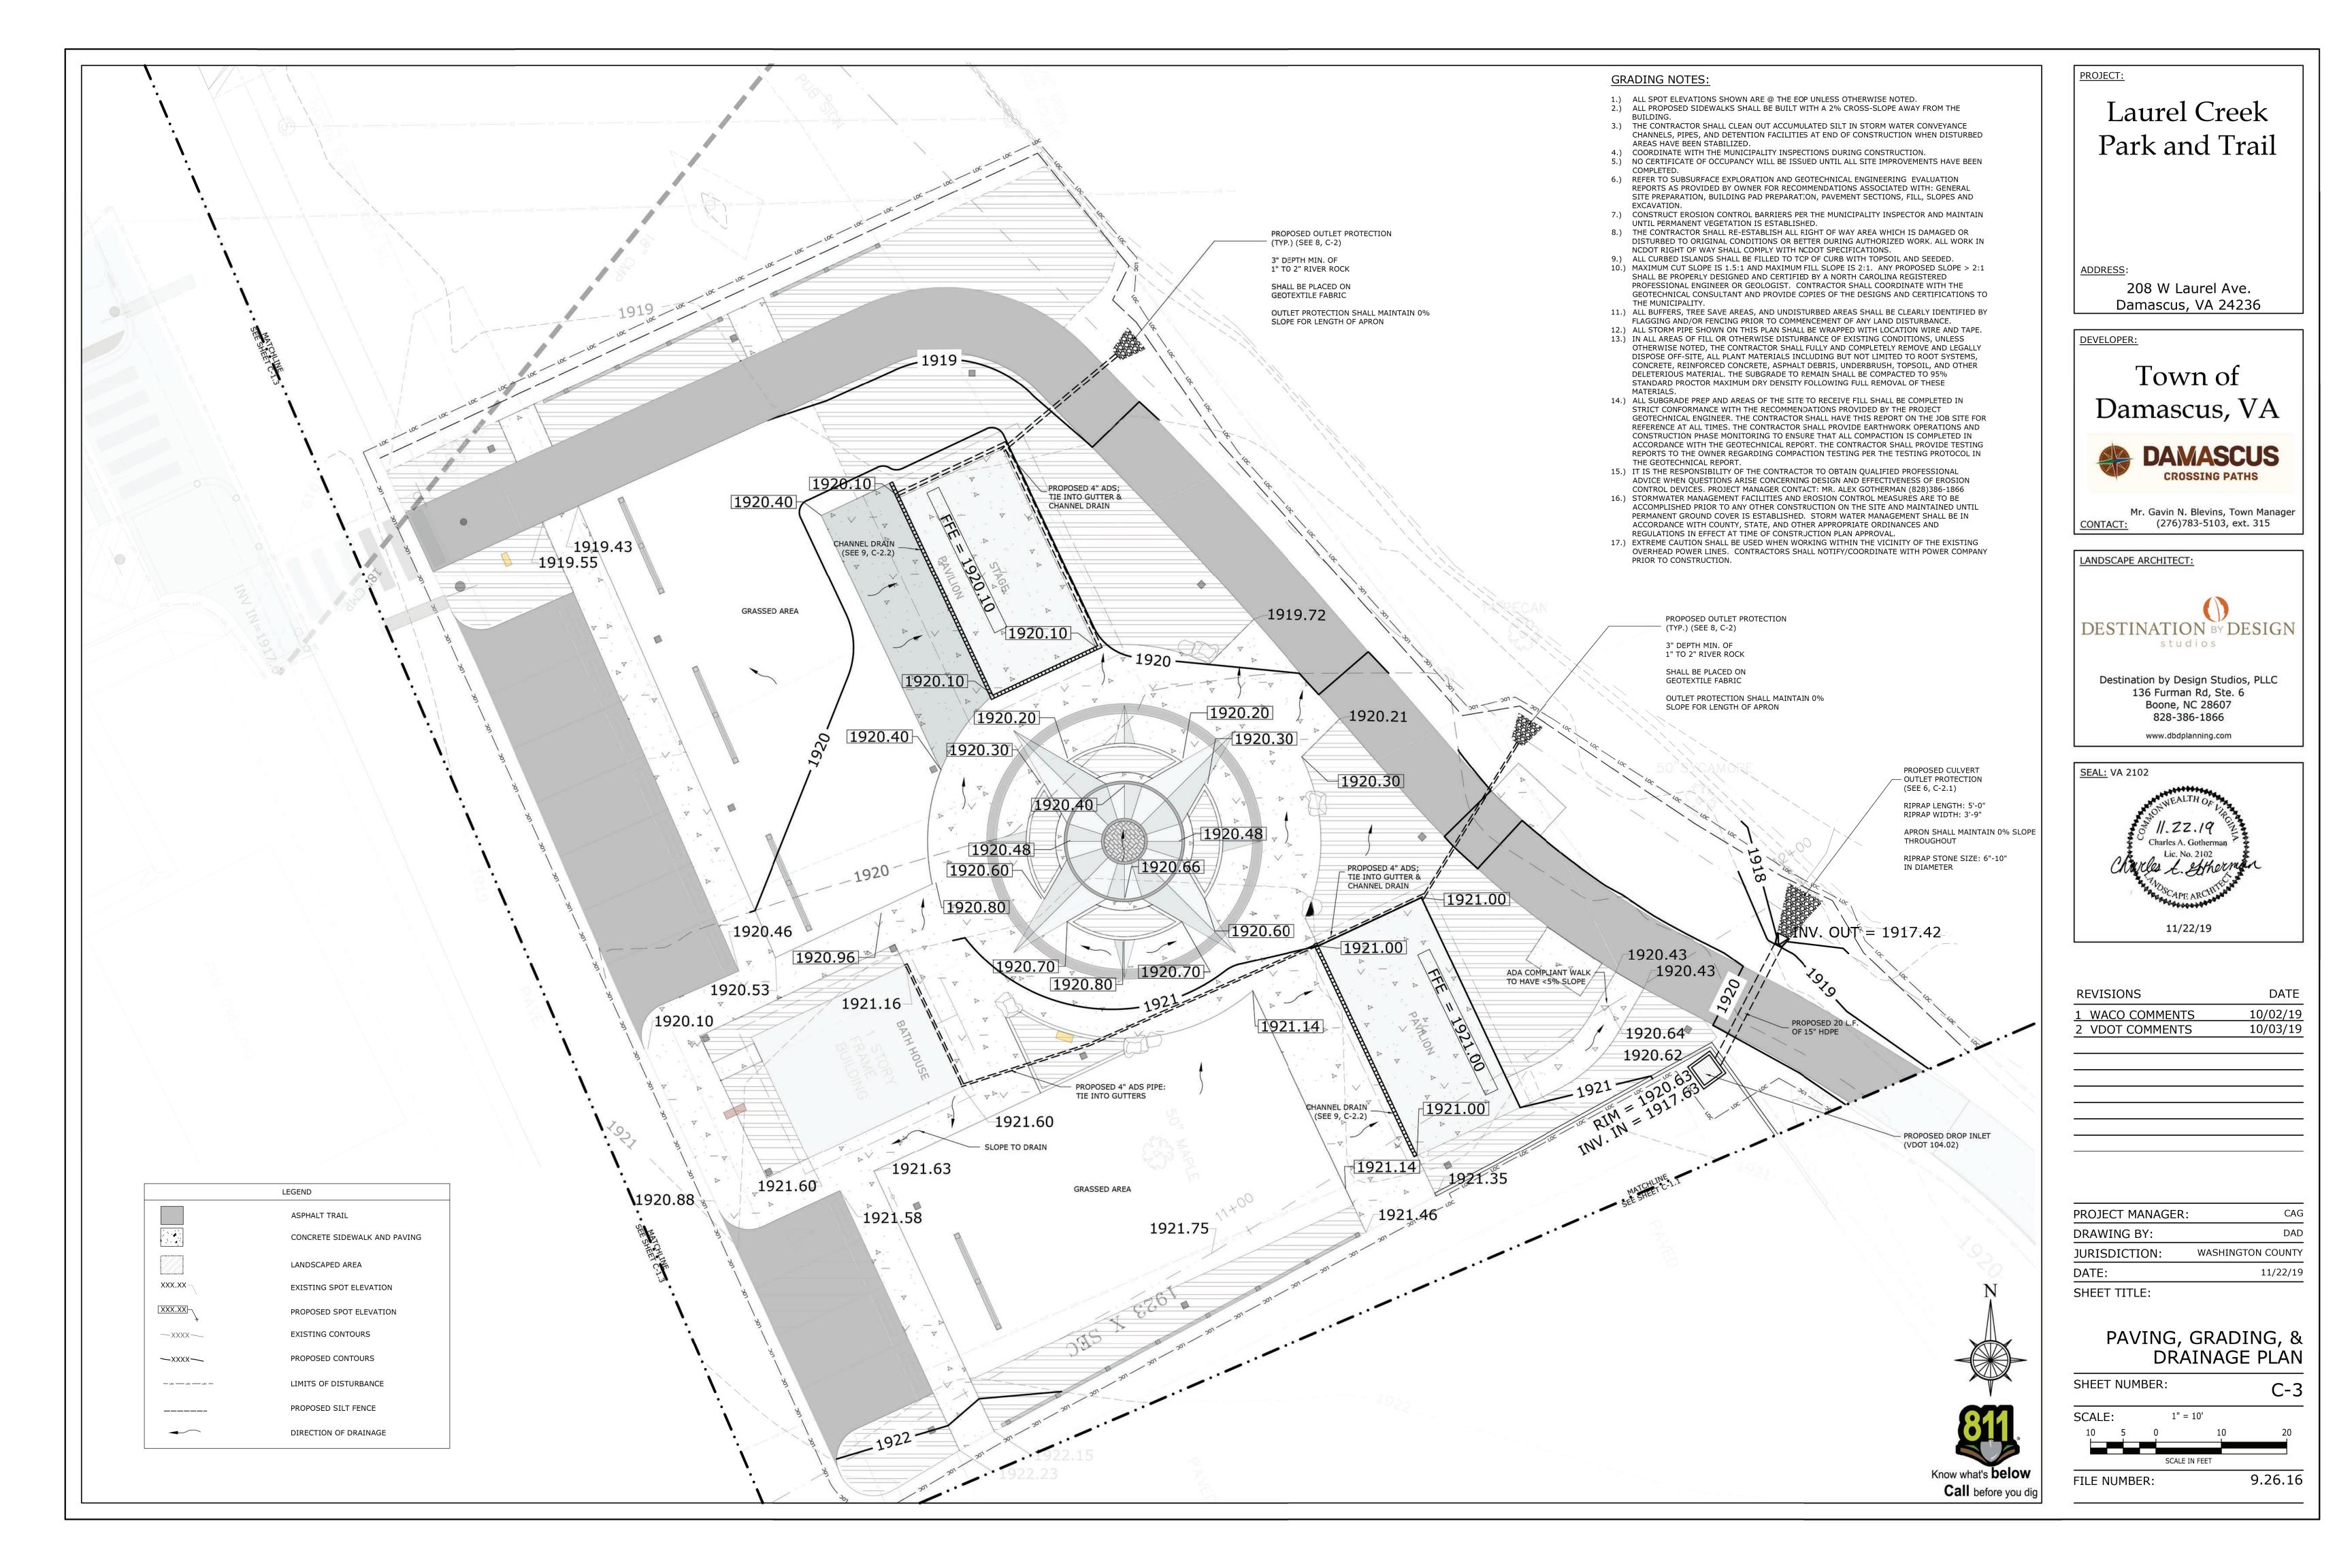


NOTES:

(1) APPROVED "RUST" COLORED POWDER COATING SHALL BE OF THE FOLLOWING (OR EQUAL APPROVED BY LANDSCAPE ARCHITECT): A. "RUST TEXTURE" BY CARDINAL (T091-BR47)

(2) ALL FASTENERS SHALL BE PAINTED SO AS TO BE INCONSPICUOUS. ALL EXPOSED HÁRDWARE SHALL BE TAMPER-RESISTANT, NON CORROSIVE FASTENERS.

(3) THE SIGN FABRICATOR/INSTALLER SHALL CHECK ALL CONTRACT DOCUMENTS, FIELD CONDITIONS, AND DIMENSIONS FOR ACCURACY AND CONFIRMING THAT ALL WORK IS BUILDABLE AS SHOWN BEFORE PROCEEDING WITH FABRICATION. IF THERE ARE ANY DISCREPANCIES OR OMISSIONS WHICH WOULD INTERFERE WITH SATISFACTORY COMPLETION OF THE WORK, THE SIGN FABRICATOR/INSTALLER SHALL OBTAIN A CLARIFICATION FROM THE LANDSCAPE ARCHITECT (DESTINATION BY DESIGN 828-386-1866) BEFORE PROCEEDING WITH THE WORK IN QUESTION.

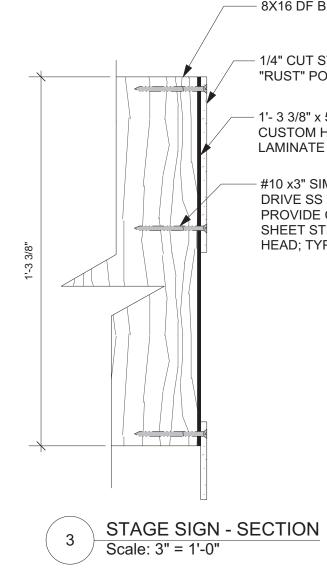

- 8X16 DF BEAM


— 1/4" CUT STEEL SHEET; "RUST" POWDER COAT; TYP.


/----- 1'- 3 3/8" x 5'-1 1/8" x 1/8" CUSTOM HIGH PRESSURE LAMINATE SIGN; TYP.


> - #10 x3" SIMPSON DWP DECK DRIVE SS WOOD SCREW; PROVIDE COUNTERSINK IN SHEET STEEL FOR SCREW HEAD; TYP.





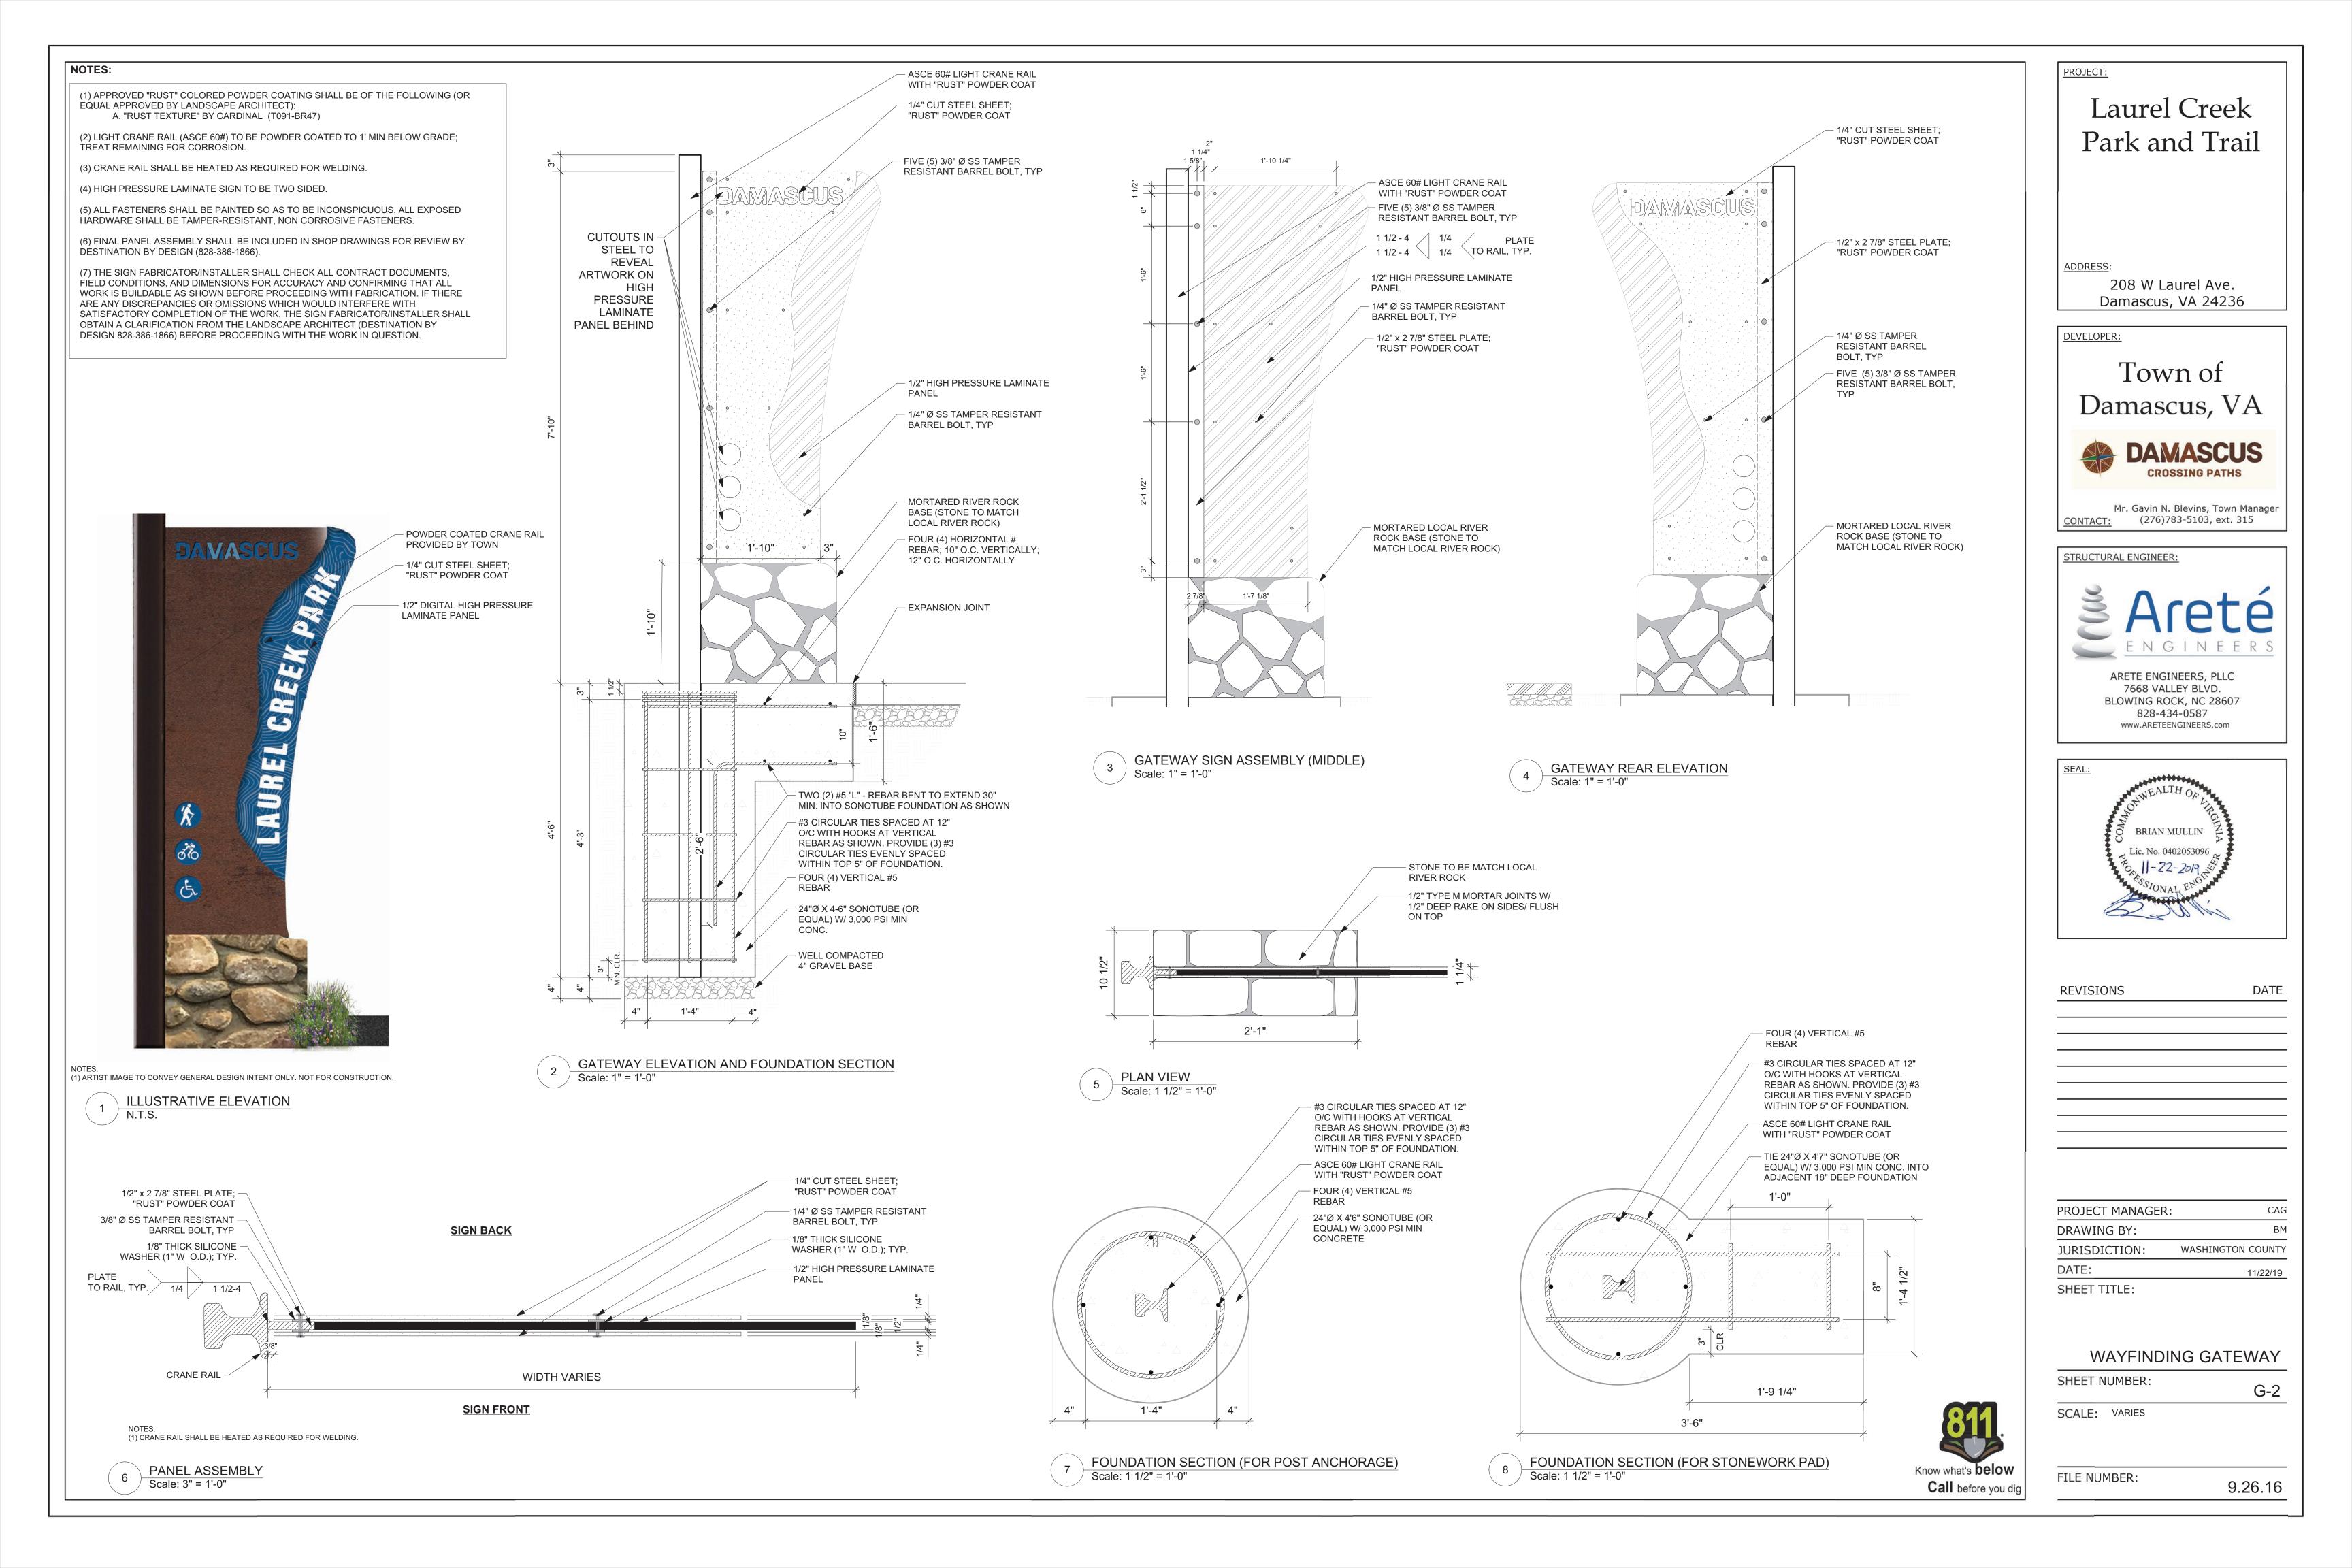

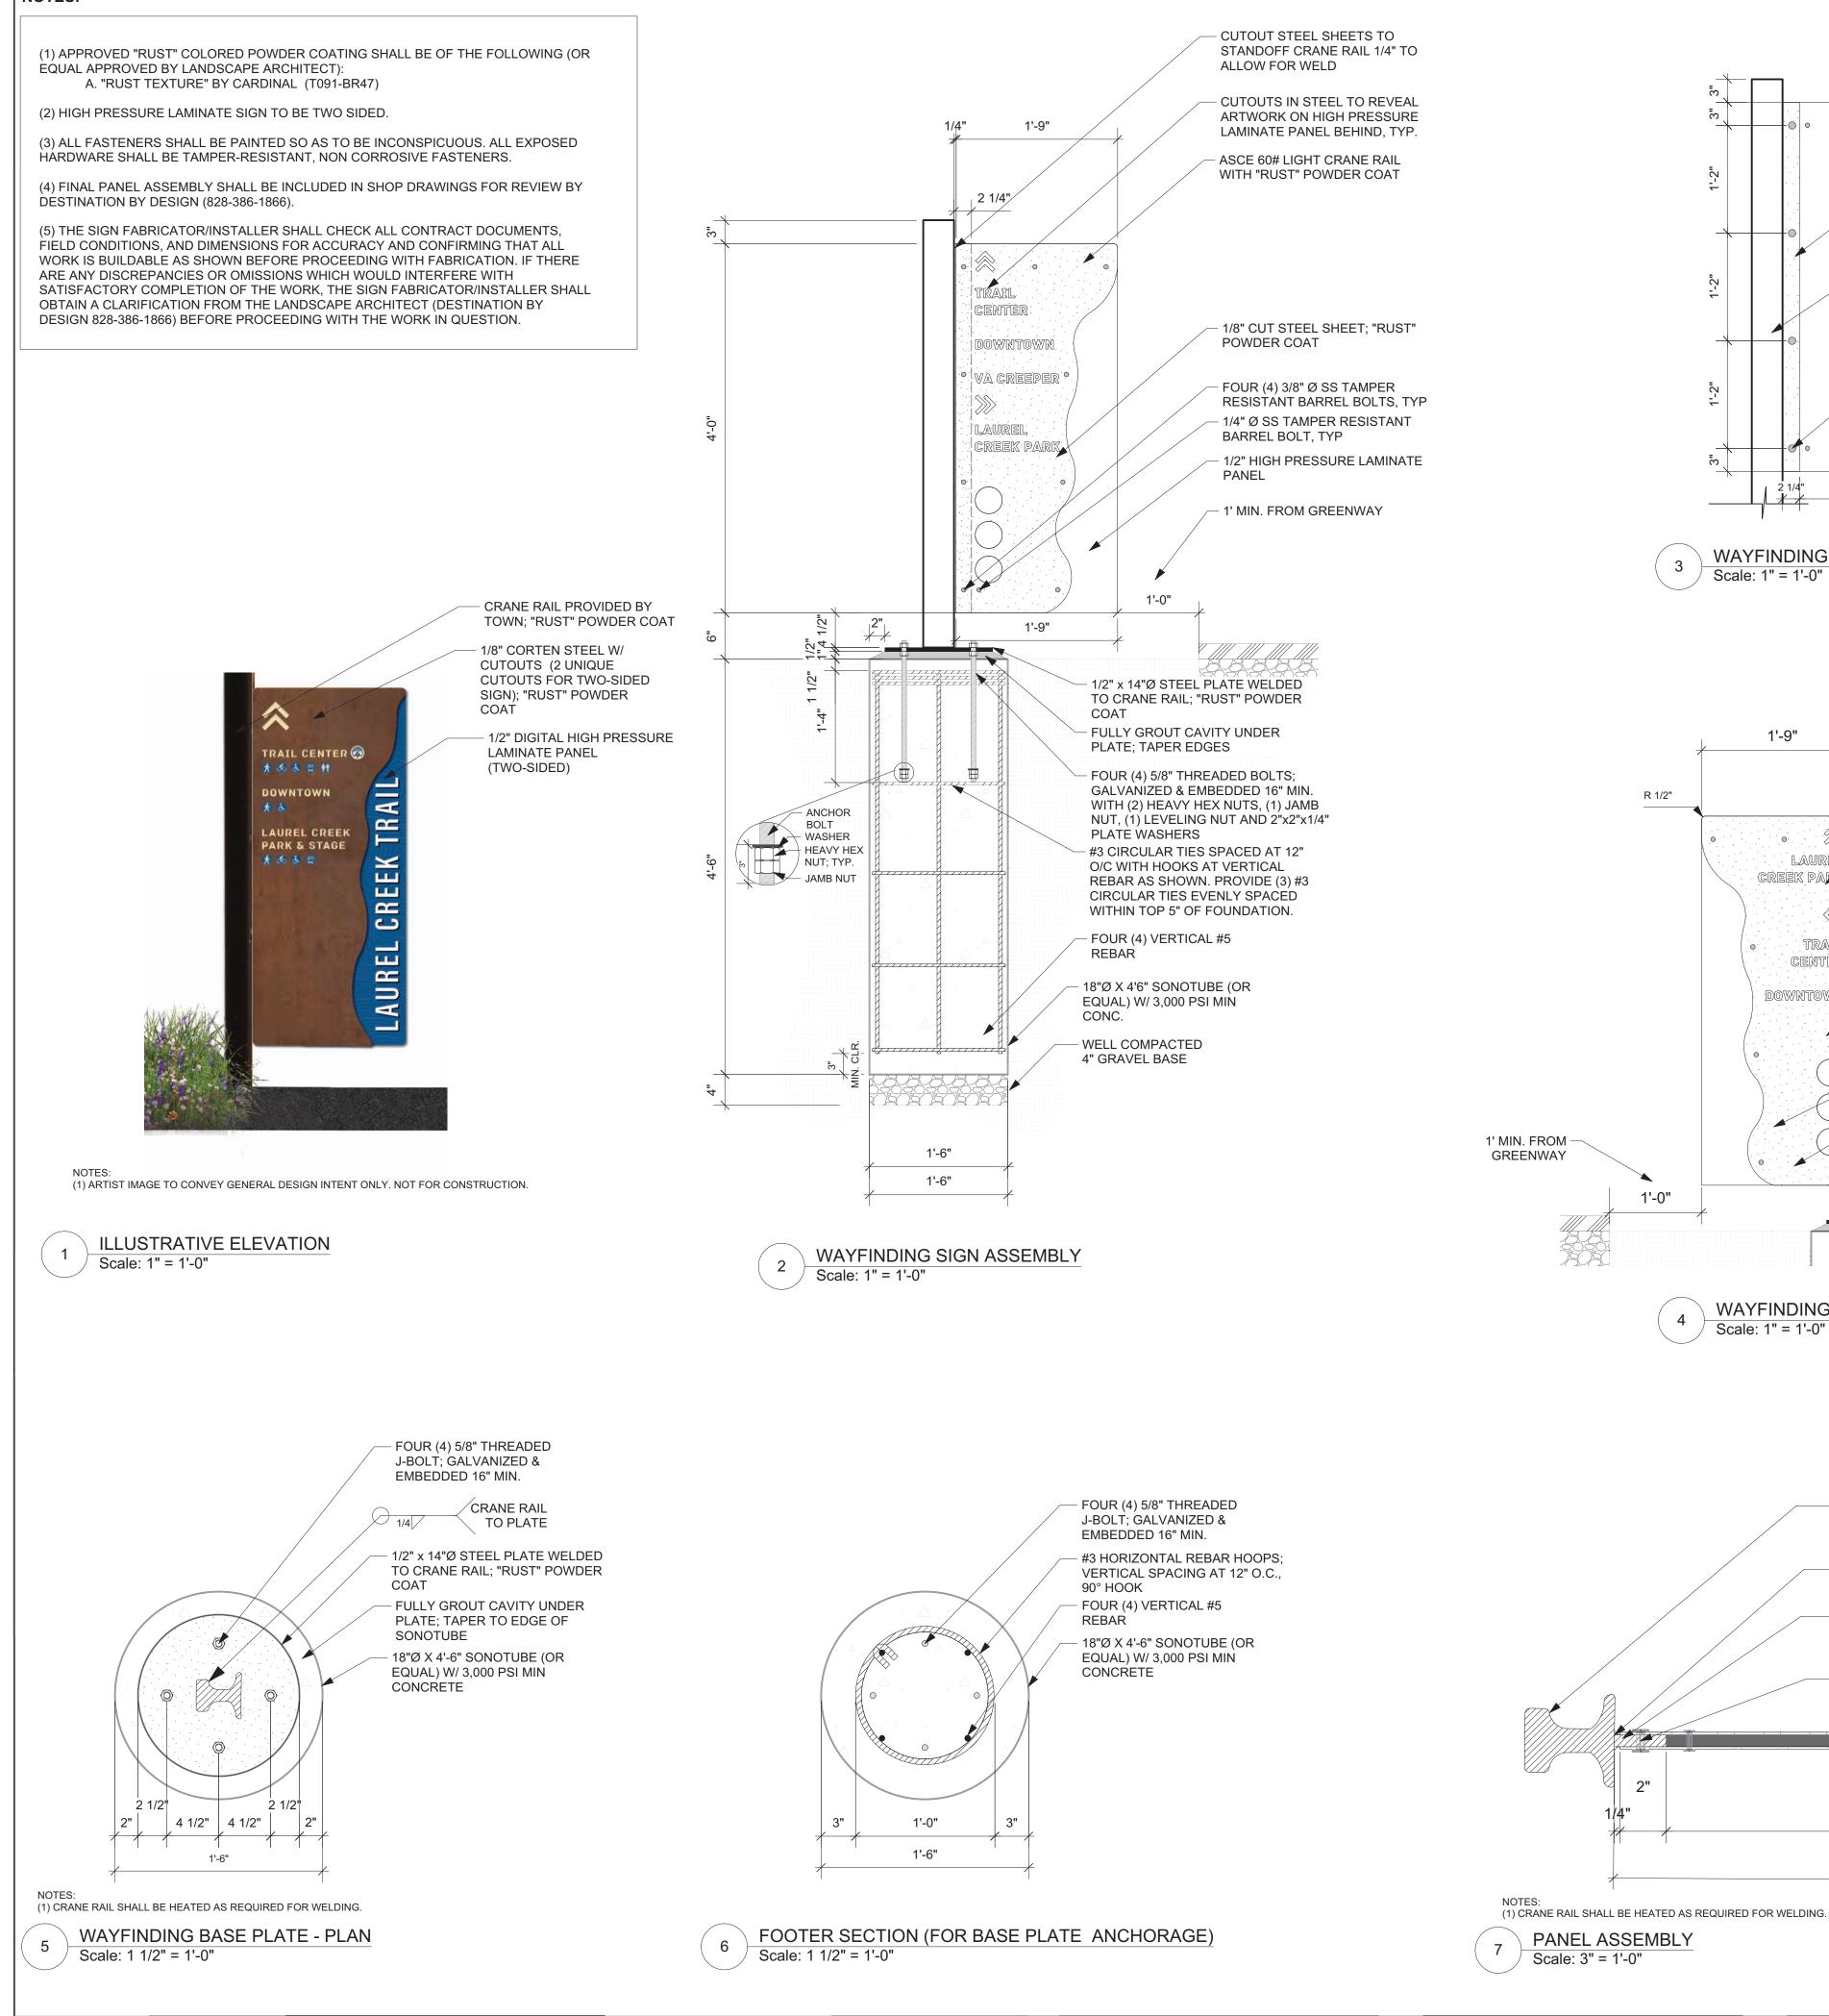

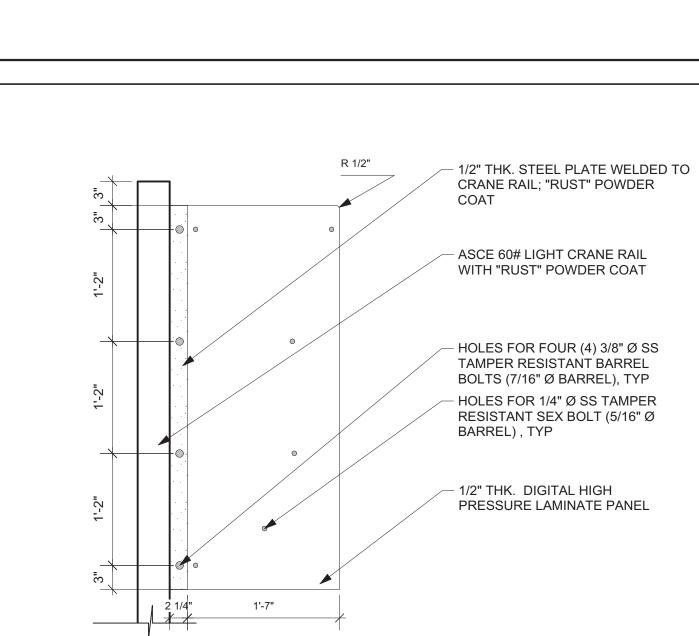



R 1/2"

1'-0"

4

1'-9"

· O · ,

CREEK PARK

1/4"

LAUREL

TRAIL

CENTER

DOWNTOWN

Scale: 1" = 1'-0"

WAYFINDING SIGN ASSEMBLY (BACK)

1'-7"

1'-9 1/4"

WAYFINDING SIGN ASSEMBLY (MIDDLE) Scale: 1" = 1'-0"

- CUTOUT STEEL SHEETS TO STANDOFF

CRANE RAIL 1/4" TO ALLOW FOR WELD

- CUTOUTS IN STEEL TO REVEAL

ARTWORK ON HIGH PRESSURE

LAMINATE PANEL BEHIND, TYP.

TOWN; "RUST" POWDER COAT

- CRANE RAIL PROVIDED BY

- 1/8" CUT STEEL SHEET;

"RUST" POWDER COAT

- FOUR (4) 3/8" Ø SS TAMPER

— 1/4" Ø SS TAMPER RESISTANT

BARREL BOLT, TYP

PANEL

RESISTANT BARREL BOLT, TYP

- 1/2" HIGH PRESSURE LAMINATE


ASCE 60# LIGHT CRANE RAIL WITH "RUST" POWDER COAT / PLATE TO 1/4 1 1/2 - 4 RAIL; TYP. - 1/2" x 2 1/4" STEEL PLATE WELDED TO CRANE RAIL; "RUST" POWDER COAT FOUR (4) 3/8" Ø SS TAMPER RESISTANT BARREL BOLT, TYP

LAMINATE PANEL BARREL BOLT, TYP

PANEL ASSEMBLY


1/4'

1/2" DIGITAL HIGH PRESSURE 1/4" Ø SS TAMPER RESISTANT

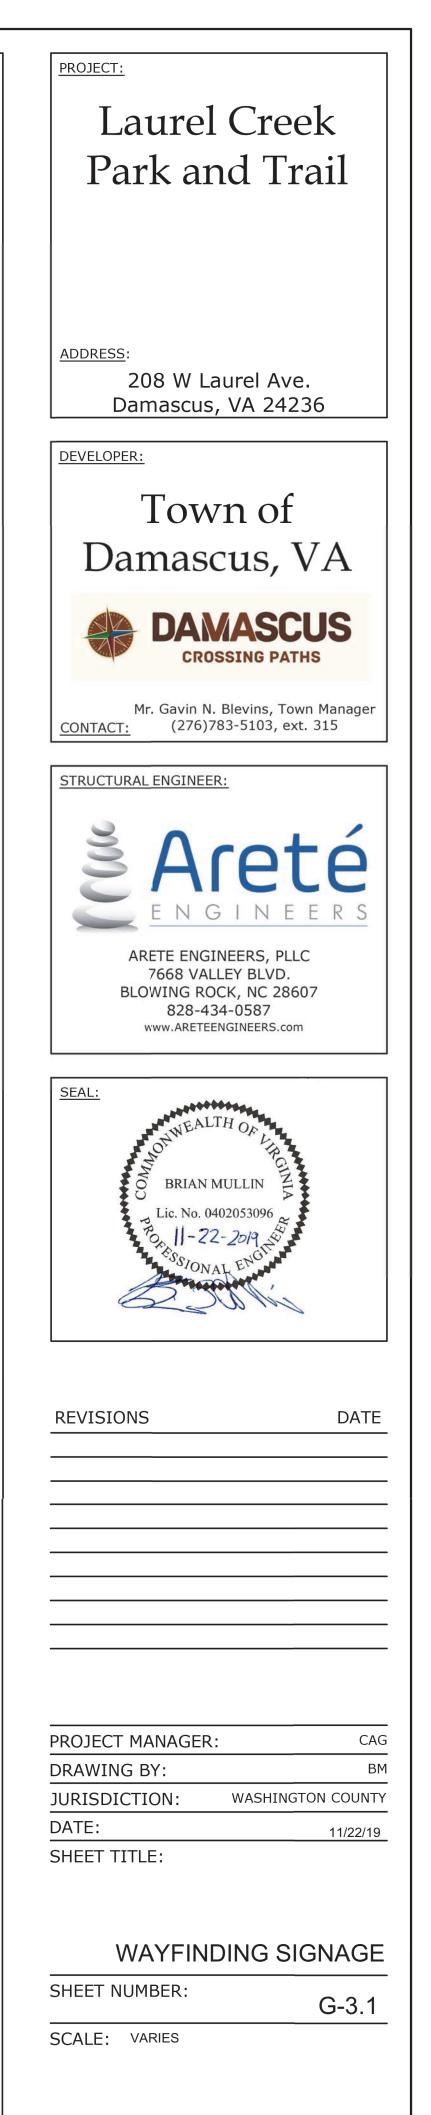



FILE NUMBER:

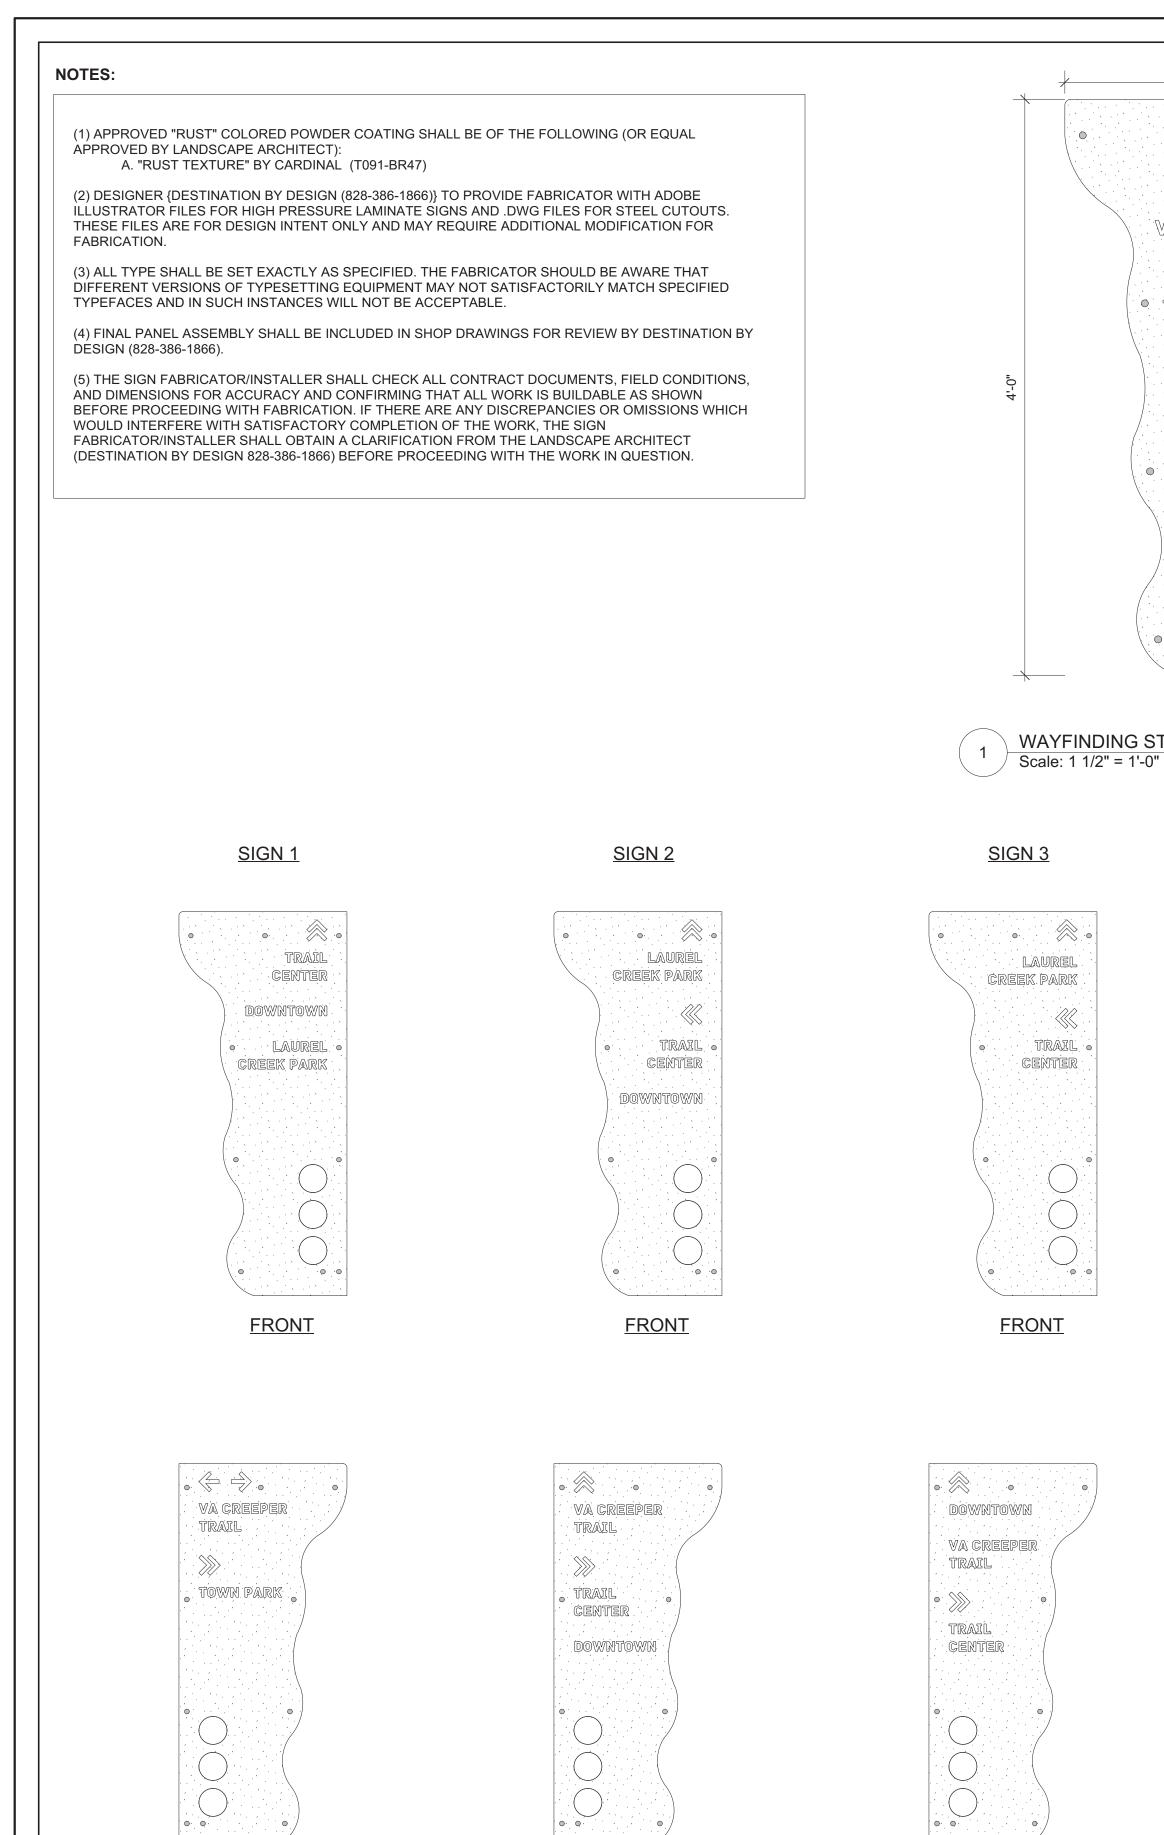

<u>BACK</u>

<u>BACK</u>

BACK

O, Q,

NOTES:

(1) ALL SIGNS TO BE LOCATED TRAIL RIGHT FOLLOWING IN NUMERICAL ORDER FROM 1 TO 7 WITH THE EXCEPTION OF SIGN #4, WHICH IS LOCATED TRAIL LEFT.

2 WAYFINDING STEEL PANELS Scale: 1" = 1'-0"

0.0.




- 1/8" CUT STEEL SHEET; "RUST" POWDER COAT - CUTOUTS IN STEEL TO REVEAL ARTWORK ON HIGH PRESSURE LAMINATE PANEL BEHIND, TYP. - FONT TO BE "ARCHIVE" - LETTERING AND ARROWS TO BE CUT OUT OF STEEL - HOLES FOR 1/4" Ø BOLTS, TYP OF 4 R 1 3/4" TYP.


> - CUTOUTS IN STEEL TO REVEAL ARTWORK ON HIGH PRESSURE LAMINATE PANEL BEHIND, TYP.

- HOLES FOR 3/8" Ø BOLTS, TYP OF 4

WAYFINDING STEEL PANELS - OVERVIEW

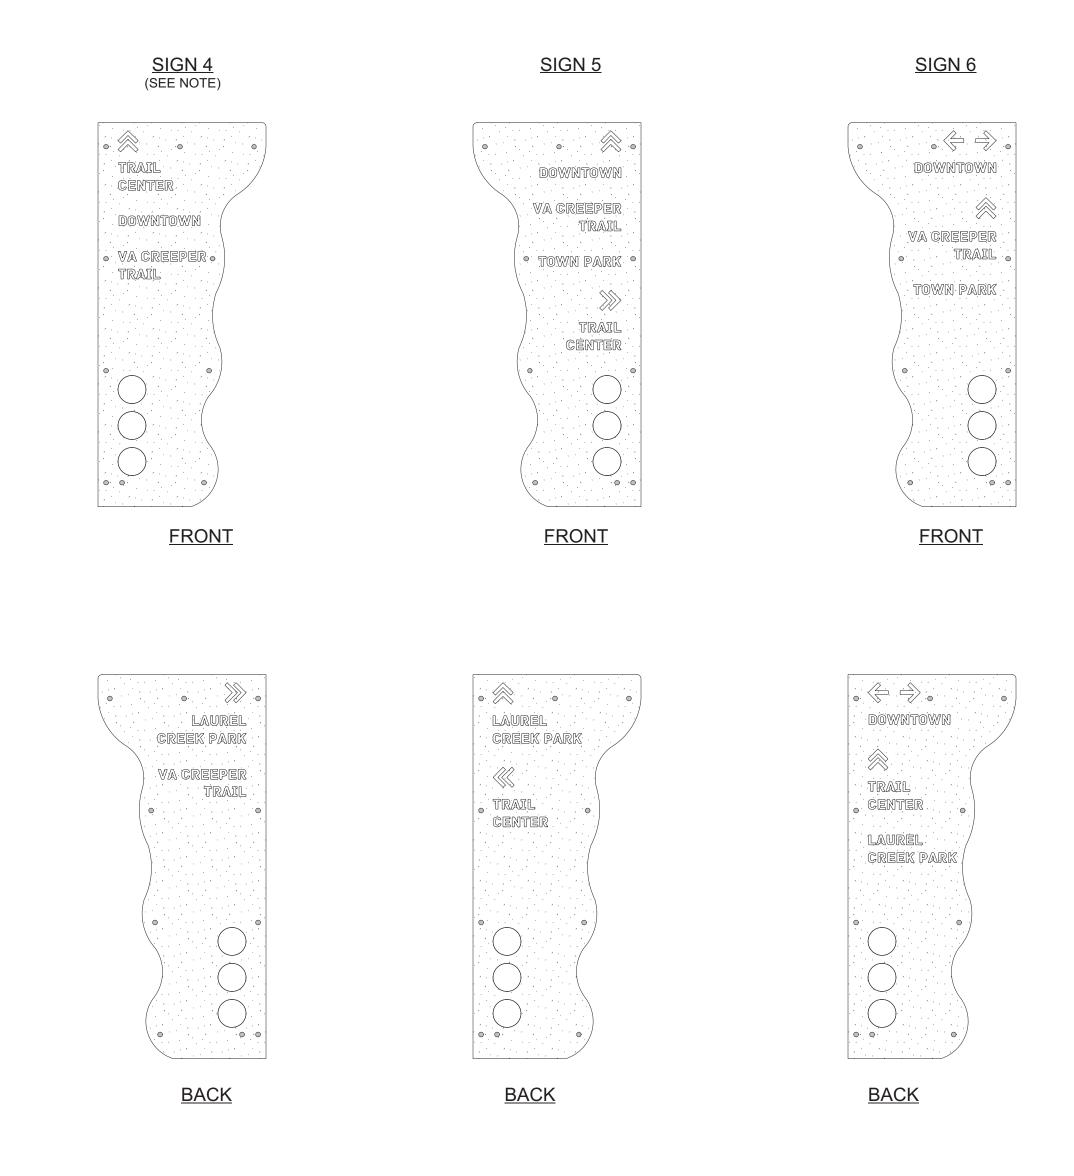



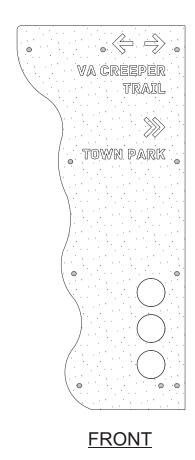









Know what's **below** Call before you dig

ID	Qty	Latin Name	Common Name	Size	Remarks
AC	4	Amelanchier canadensis	Shadblow Serviceberry	6'	Multi-stem, stand alone specimen quality Suggested substitute: Amelanchier 'Princess Diana'
AC-V	67	Astilbe chinensis 'Visions'	Visions Astilbe	1 GL	
AG	31	Andropogon gerardii 'Red October'	Red October Big Bluestem	1 GL	
AP	25	Anemone x 'Pamina'	Pamina Japanese Anemone	1 GL	
BMJ-G	26	Buxus microphylla japonica 'Gregem'	Baby Gem Boxwood	3 GL	
B-PS	24	Baptisia hybrid	False Indigo	1 GL	
СС	12	Cercis canadensis	Eastern Redbud	6'	on standard
CF - AS	1	Cornus florida 'Appalachian Spring'	Appalachian Spring Dogwood	15 GL/4'	suggested substitute: Cornus "Jean's Appalachian Snow'
CV	1	Chionanthus virginicus	White Fringe Tree	6'	Multi-stem
CVM	31	Coreopsis verticillata 'Moonbeam'	Moonbeam Threadleaf Tickseed	1 GL	
DP	25	Dennstaedtia punctilobula	Hay-scented Fern	QT	
HG	10	Hosta x 'Guacamole'	Guacamole Plantain Lily	1 GL	
HP-LQ	24	Hydrangea paniculata 'SMHPLQF' USPP 25136	Little Quick Fire® Hardy Hydrangea	3 GL	
HQ-SQ	13	Hydrangea quercifolia 'Snow Queen'	Snow Queen Oakleaf Hydrangea	5 GL	
IV-S	51	Itea virginica 'Sprich'	Little Henry® Sweetspire	3 GL	
JC-S	18	Juniperus chinensis 'Sargentii'	Sargent's Juniper	3 GL	
L- TF	23	Lupinus	Lupine	1 GL	'Tutti Frutti' or mix of 'Bicolor'
LS-K	39	Liatris spicata 'Kobold'	Kobold Gayfeather	1 GL	
MV	3	Magnolia virginiana	Sweet Bay Magnolia	6'	
NS	4	Nyssa sylvatica	Tupelo, Black Gum	2.5-3" cal	Suggested cultivars 'Wildfire', 'Green Gable', 'David Odom
PA	1	Picea abies	Norway Spruce	8-10'	
PO	2	Platanus occidentalis	Sycamore	2.5-3" cal	
PQ	6	Parthenocissus quinquefolia	Virginia Creeper	2 GL	
R - RE	8	Rhododendron 'Roseum Elegans'	Roseum Elegans Rhododendron	3-4'	'English Roseum', 'Roseum Pink' and 'Boursalt' are sugges
RF-G	148	Rudbeckia fulgida 'Goldsturm'	Goldsturm Black Eyed Susan	1 GL	
RH-S	66	Rudbeckia hirta 'Spotlight'	Black eyed Susan	1 GL	
SA	64	Sesleria autumnalis	Autumn Moor Grass	1 GL	
S-AJ	42	Sedum 'Autumn Joy'	Autumn Joy Stonecrop	1 GL	
SH	118	Sporobolus heterolepis	Prairie Dropseed	1 GL	
SH-T	226	Sporobolus heterolepis 'Tara'	Prairie Dropseed	1 GL	
SJ-Y	40	Spiraea japonica 'Yan' USPP 21615	Double Play® Gold Spirea	3 GL	
TM-E	33	Taxus x media 'Everlow'	Everlow Spreading Yew	3 GL	
VD-C	14	Viburnum dentatum 'Christom'	Blue Muffin® Arrowwood Viburnum	5 GL	
VD-CL	8	Viburnum dentatum 'Chicago Lustre'	Chicago Lustre Viburnum	7 GL	
VP-G	10	Veronica peduncularis 'Georgia Blue' (V. umbrosa)	Georgia Blue Speedwell	1 GL	

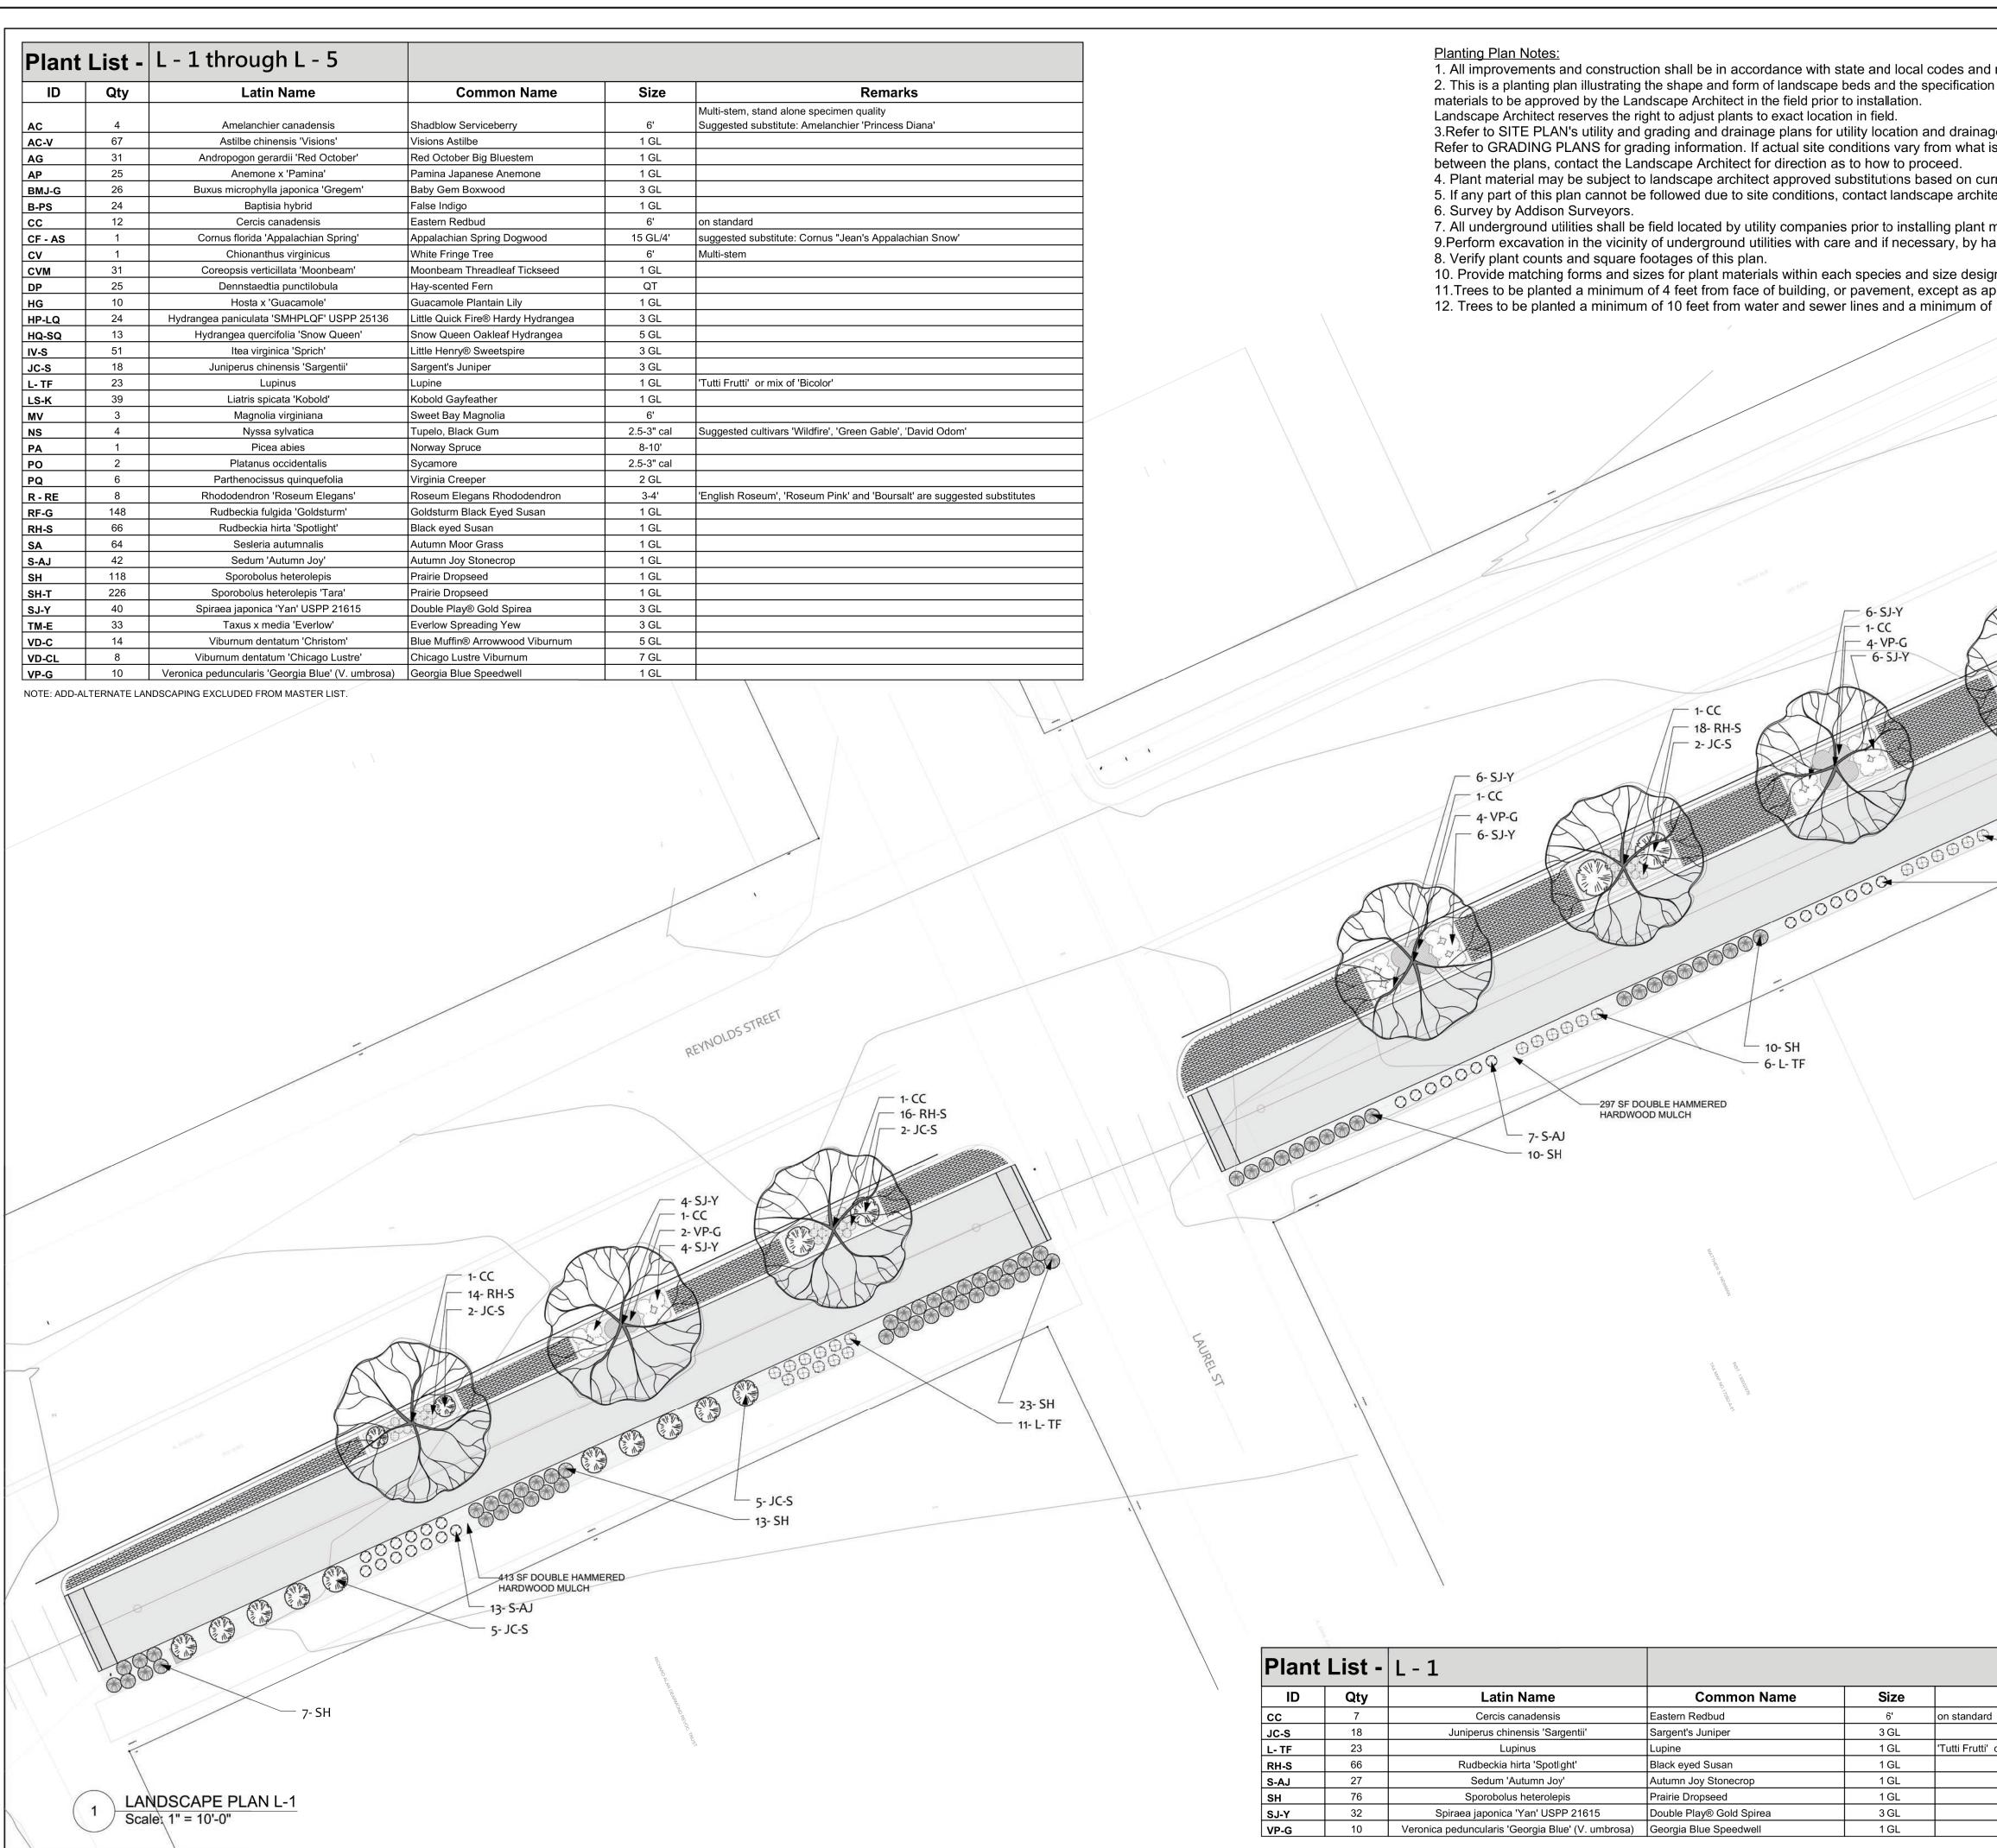

d regulations.	PROJECT:
on and placement of plants on the site. Exact locations of plant	Laurel Creek Park and Trail
age information. is shown on the plans or if there are discrepancies	
urrent nursery availability. itect prior to commencing work.	
and.	
ignated on the drawings. approved by Landscape Architect. of 15 feet from electrical and gas lines.	ADDRESS: 208 W Laurel Ave. Damascus, VA 24236
	DEVELOPER:
	Town of
	Damascus, VA
	CROSSING PATHS
- 18- RH-S 2- JC-S	Mr. Gavin N. Blevins, Town Manager <u>CONTACT:</u> (276)783-5103, ext. 315
	LANDSCAPE ARCHITECT:
	DESTINATION BY DESIGN
13- SH	Destination by Design Studios, PLLC 136 Furman Rd, Ste. 6 Boone, NC 28607 828-386-1866
6- L- TF 7- S-AJ	www.dbdplanning.com
	SEAL: VA 2102 SEAL: VA 2102 SEAL: VA 2102 SEAL: VA 2102 SCAPE ARCHITCOM 11/22/19
	REVISIONS DATE
	PROJECT MANAGER: CAG
1,	DRAWING BY: DAD
	JURISDICTION: WASHINGTON COUNTY DATE: 11/22/19 SHEET TITLE:
	LANDSCAPE PLAN
Remarks	SHEET NUMBER:
i' or mix of 'Bicolor'	SCALE: 1"=10'
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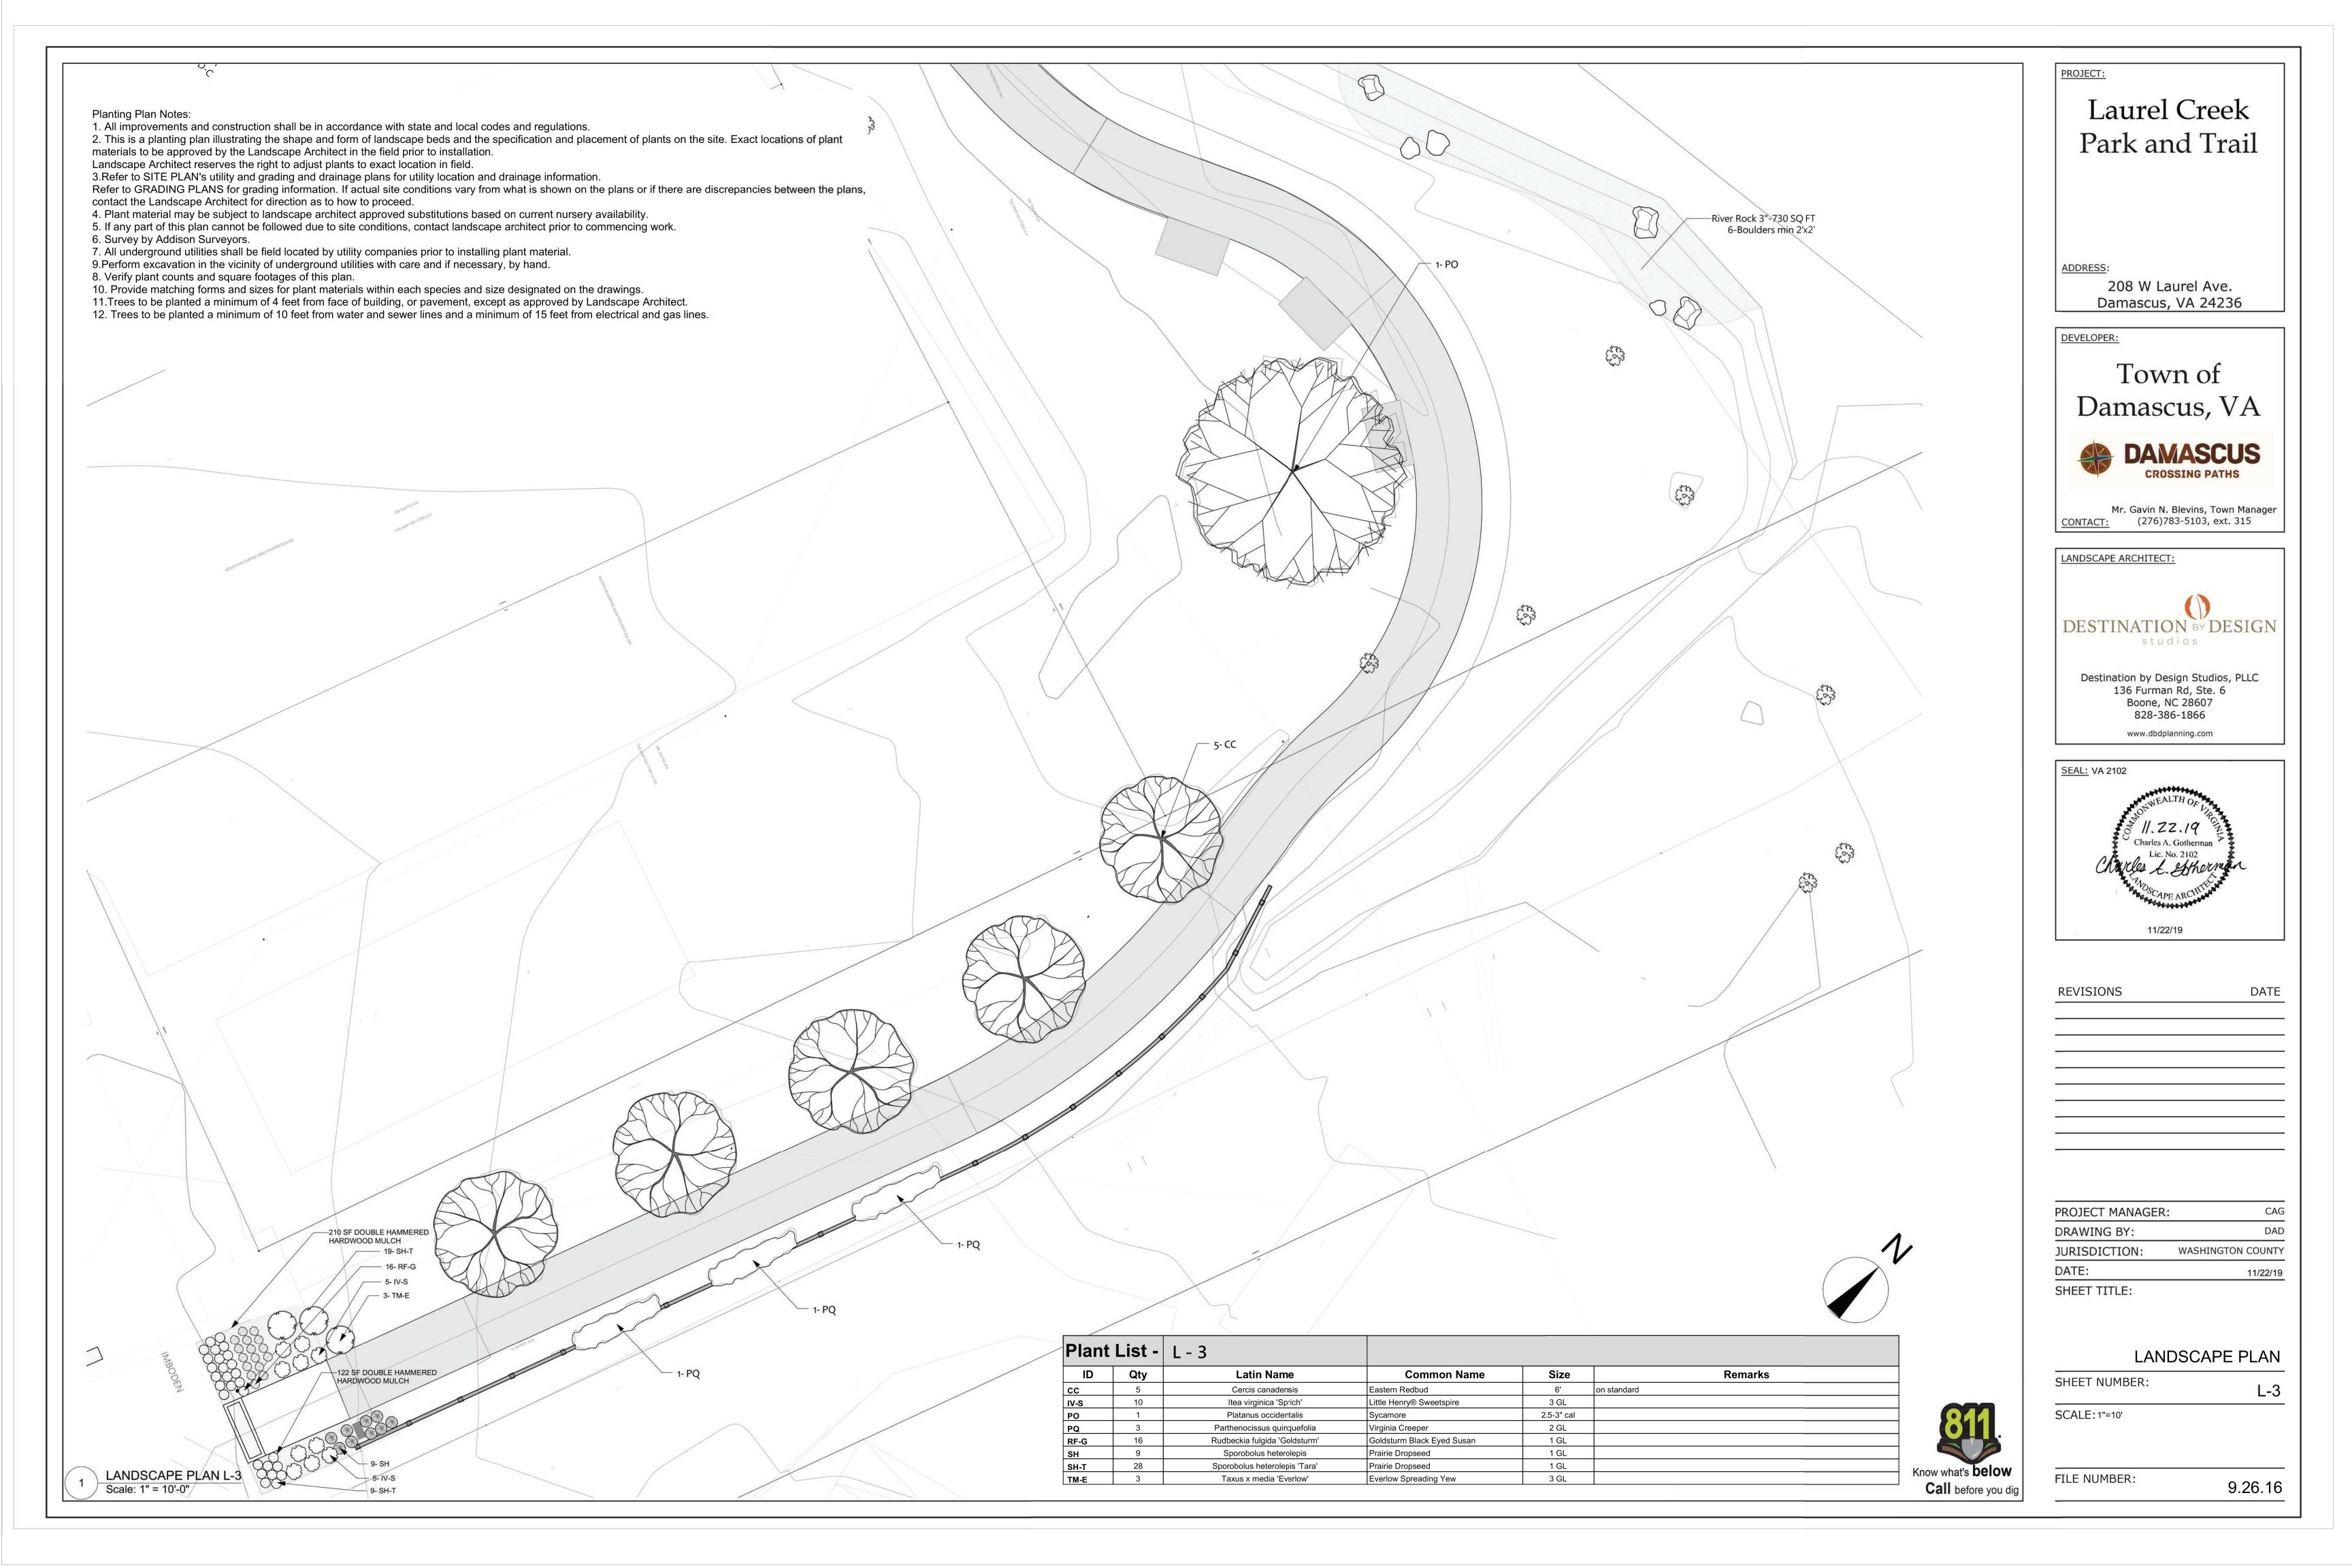
DESTINATION BY DESIGN studios Destination by Design Studios, PLLC 136 Furman Rd, Ste. 6 Boone, NC 28607 828-386-1866 www.dbdplanning.com Charles A. Gotherman Lic. No. 2102 Rucles L. Stherman DATE

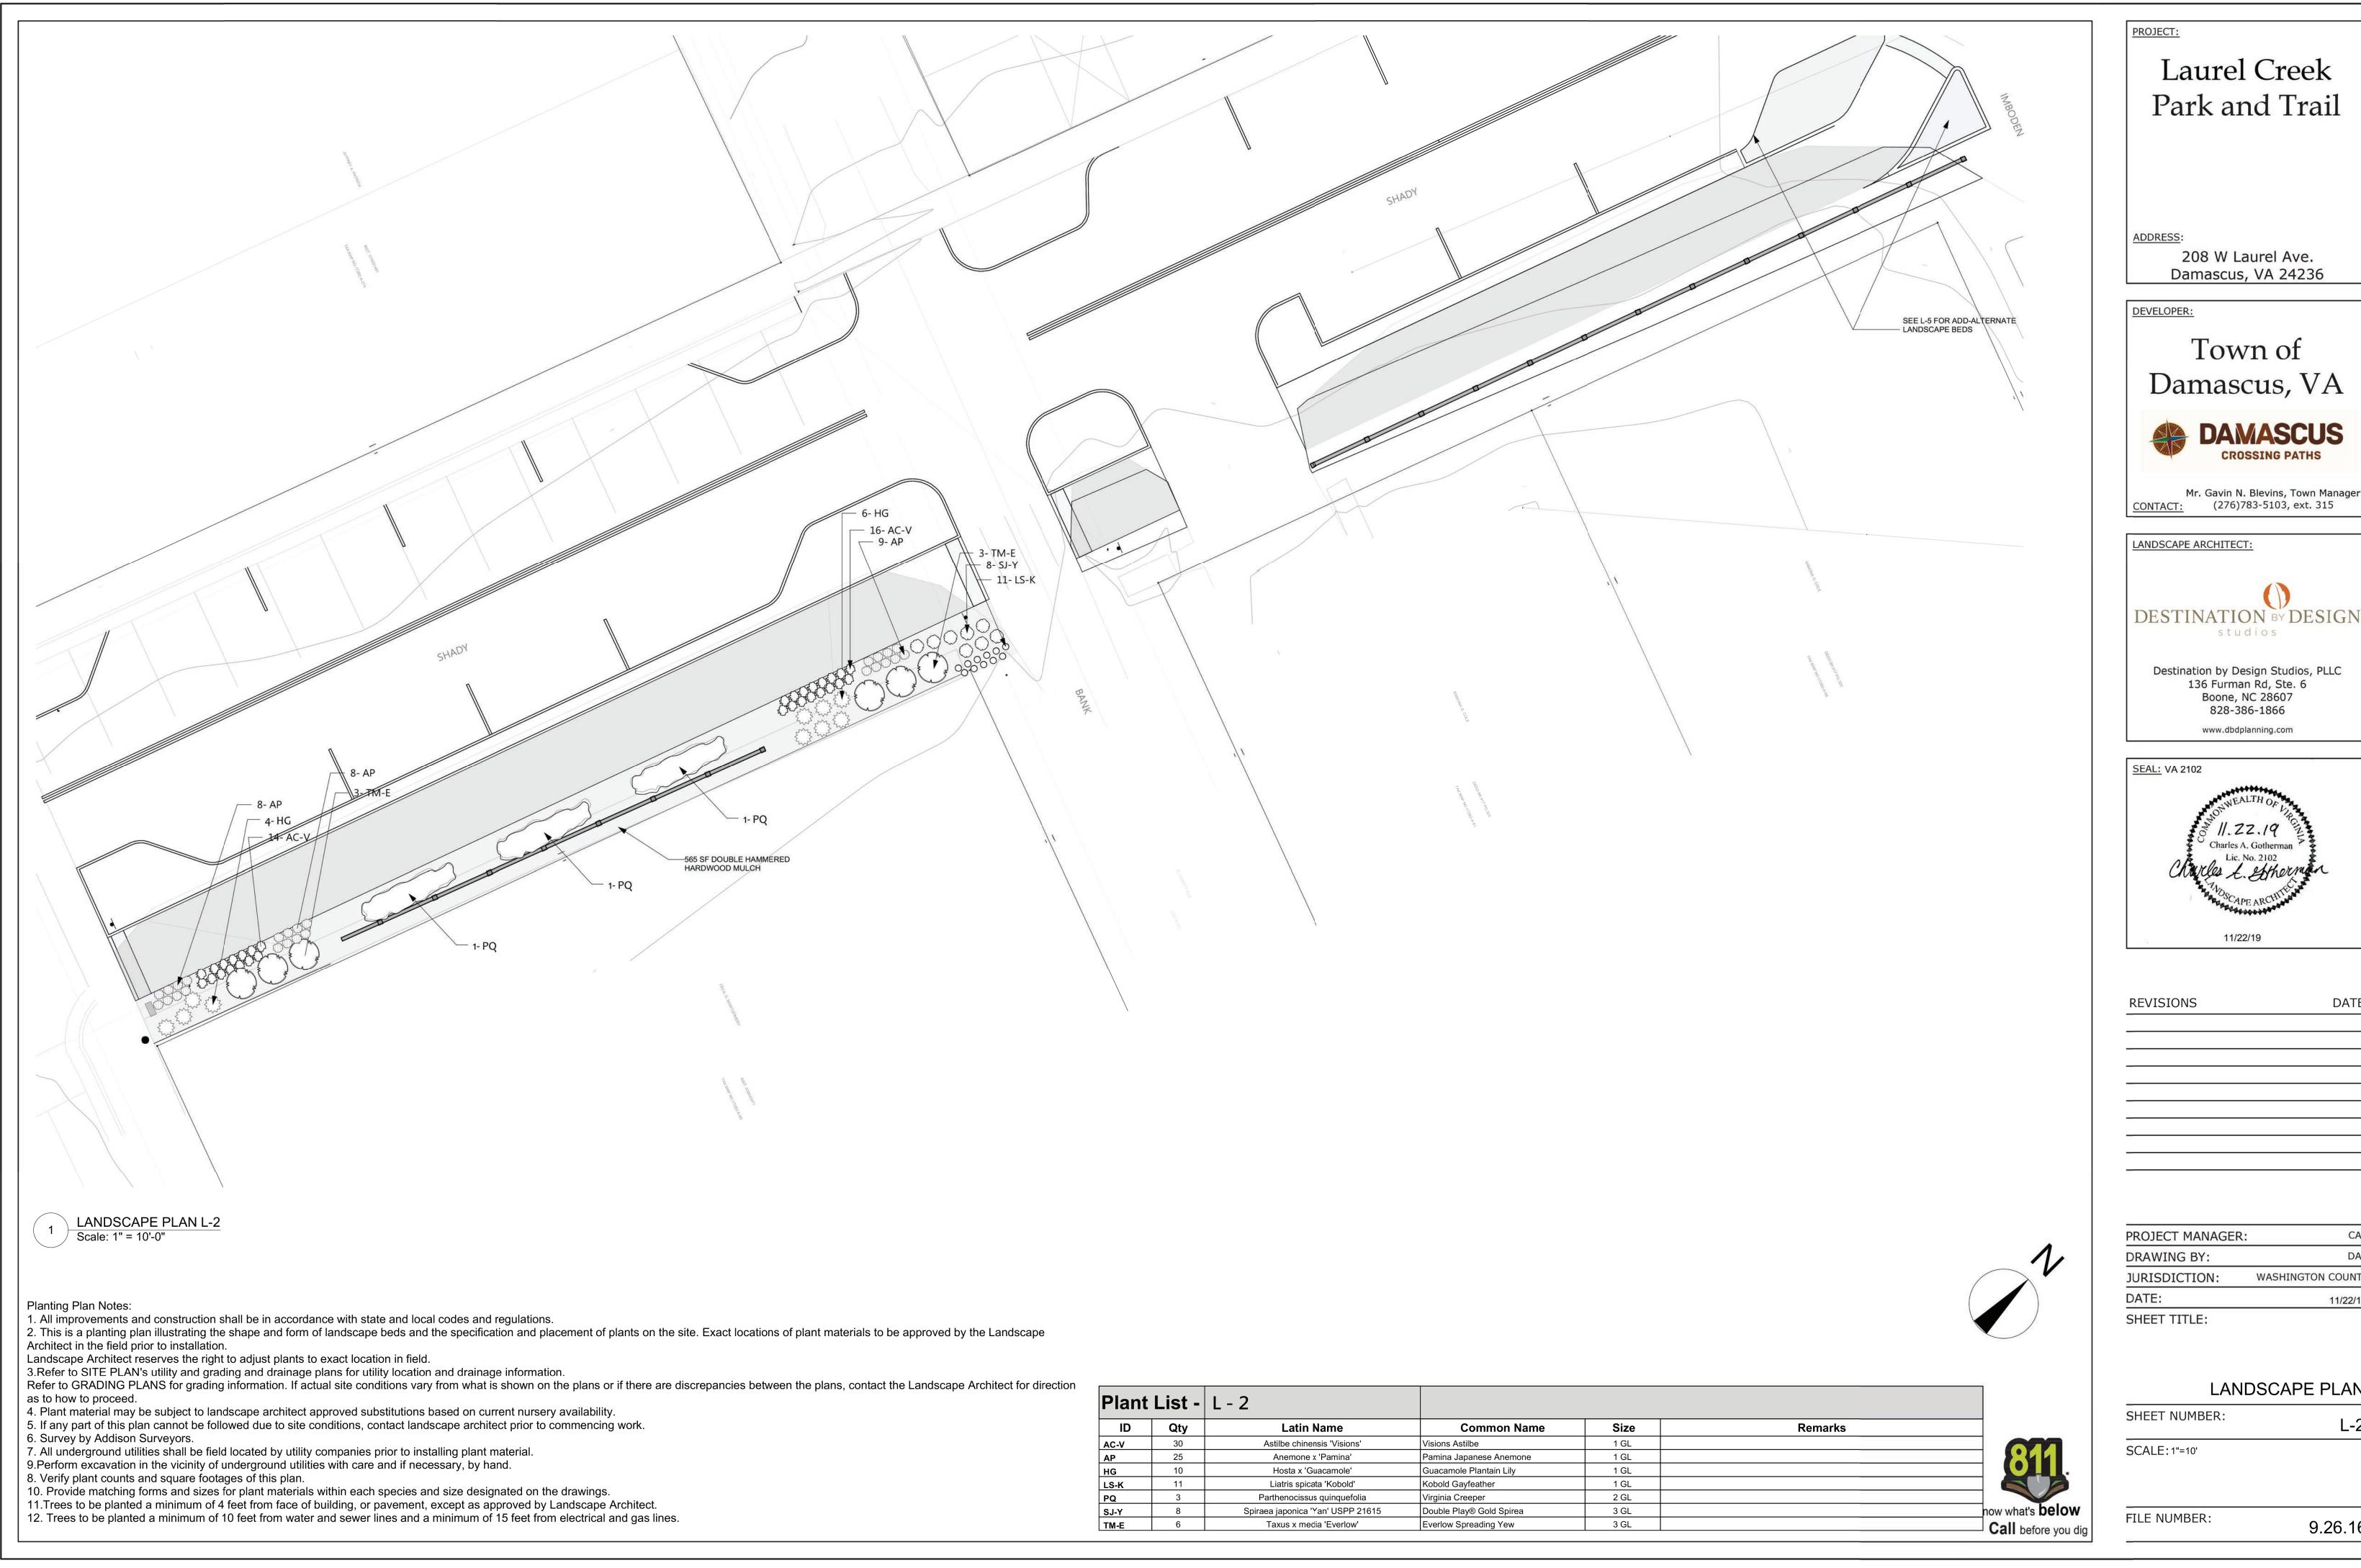
PROJECT MANAGER:	CAG
DRAWING BY:	DAD
JURISDICTION:	WASHINGTON COUNTY
DATE:	11/22/19
SHEET TITLE:	

LANDSCAPE PLAN

9.26.16

L-2




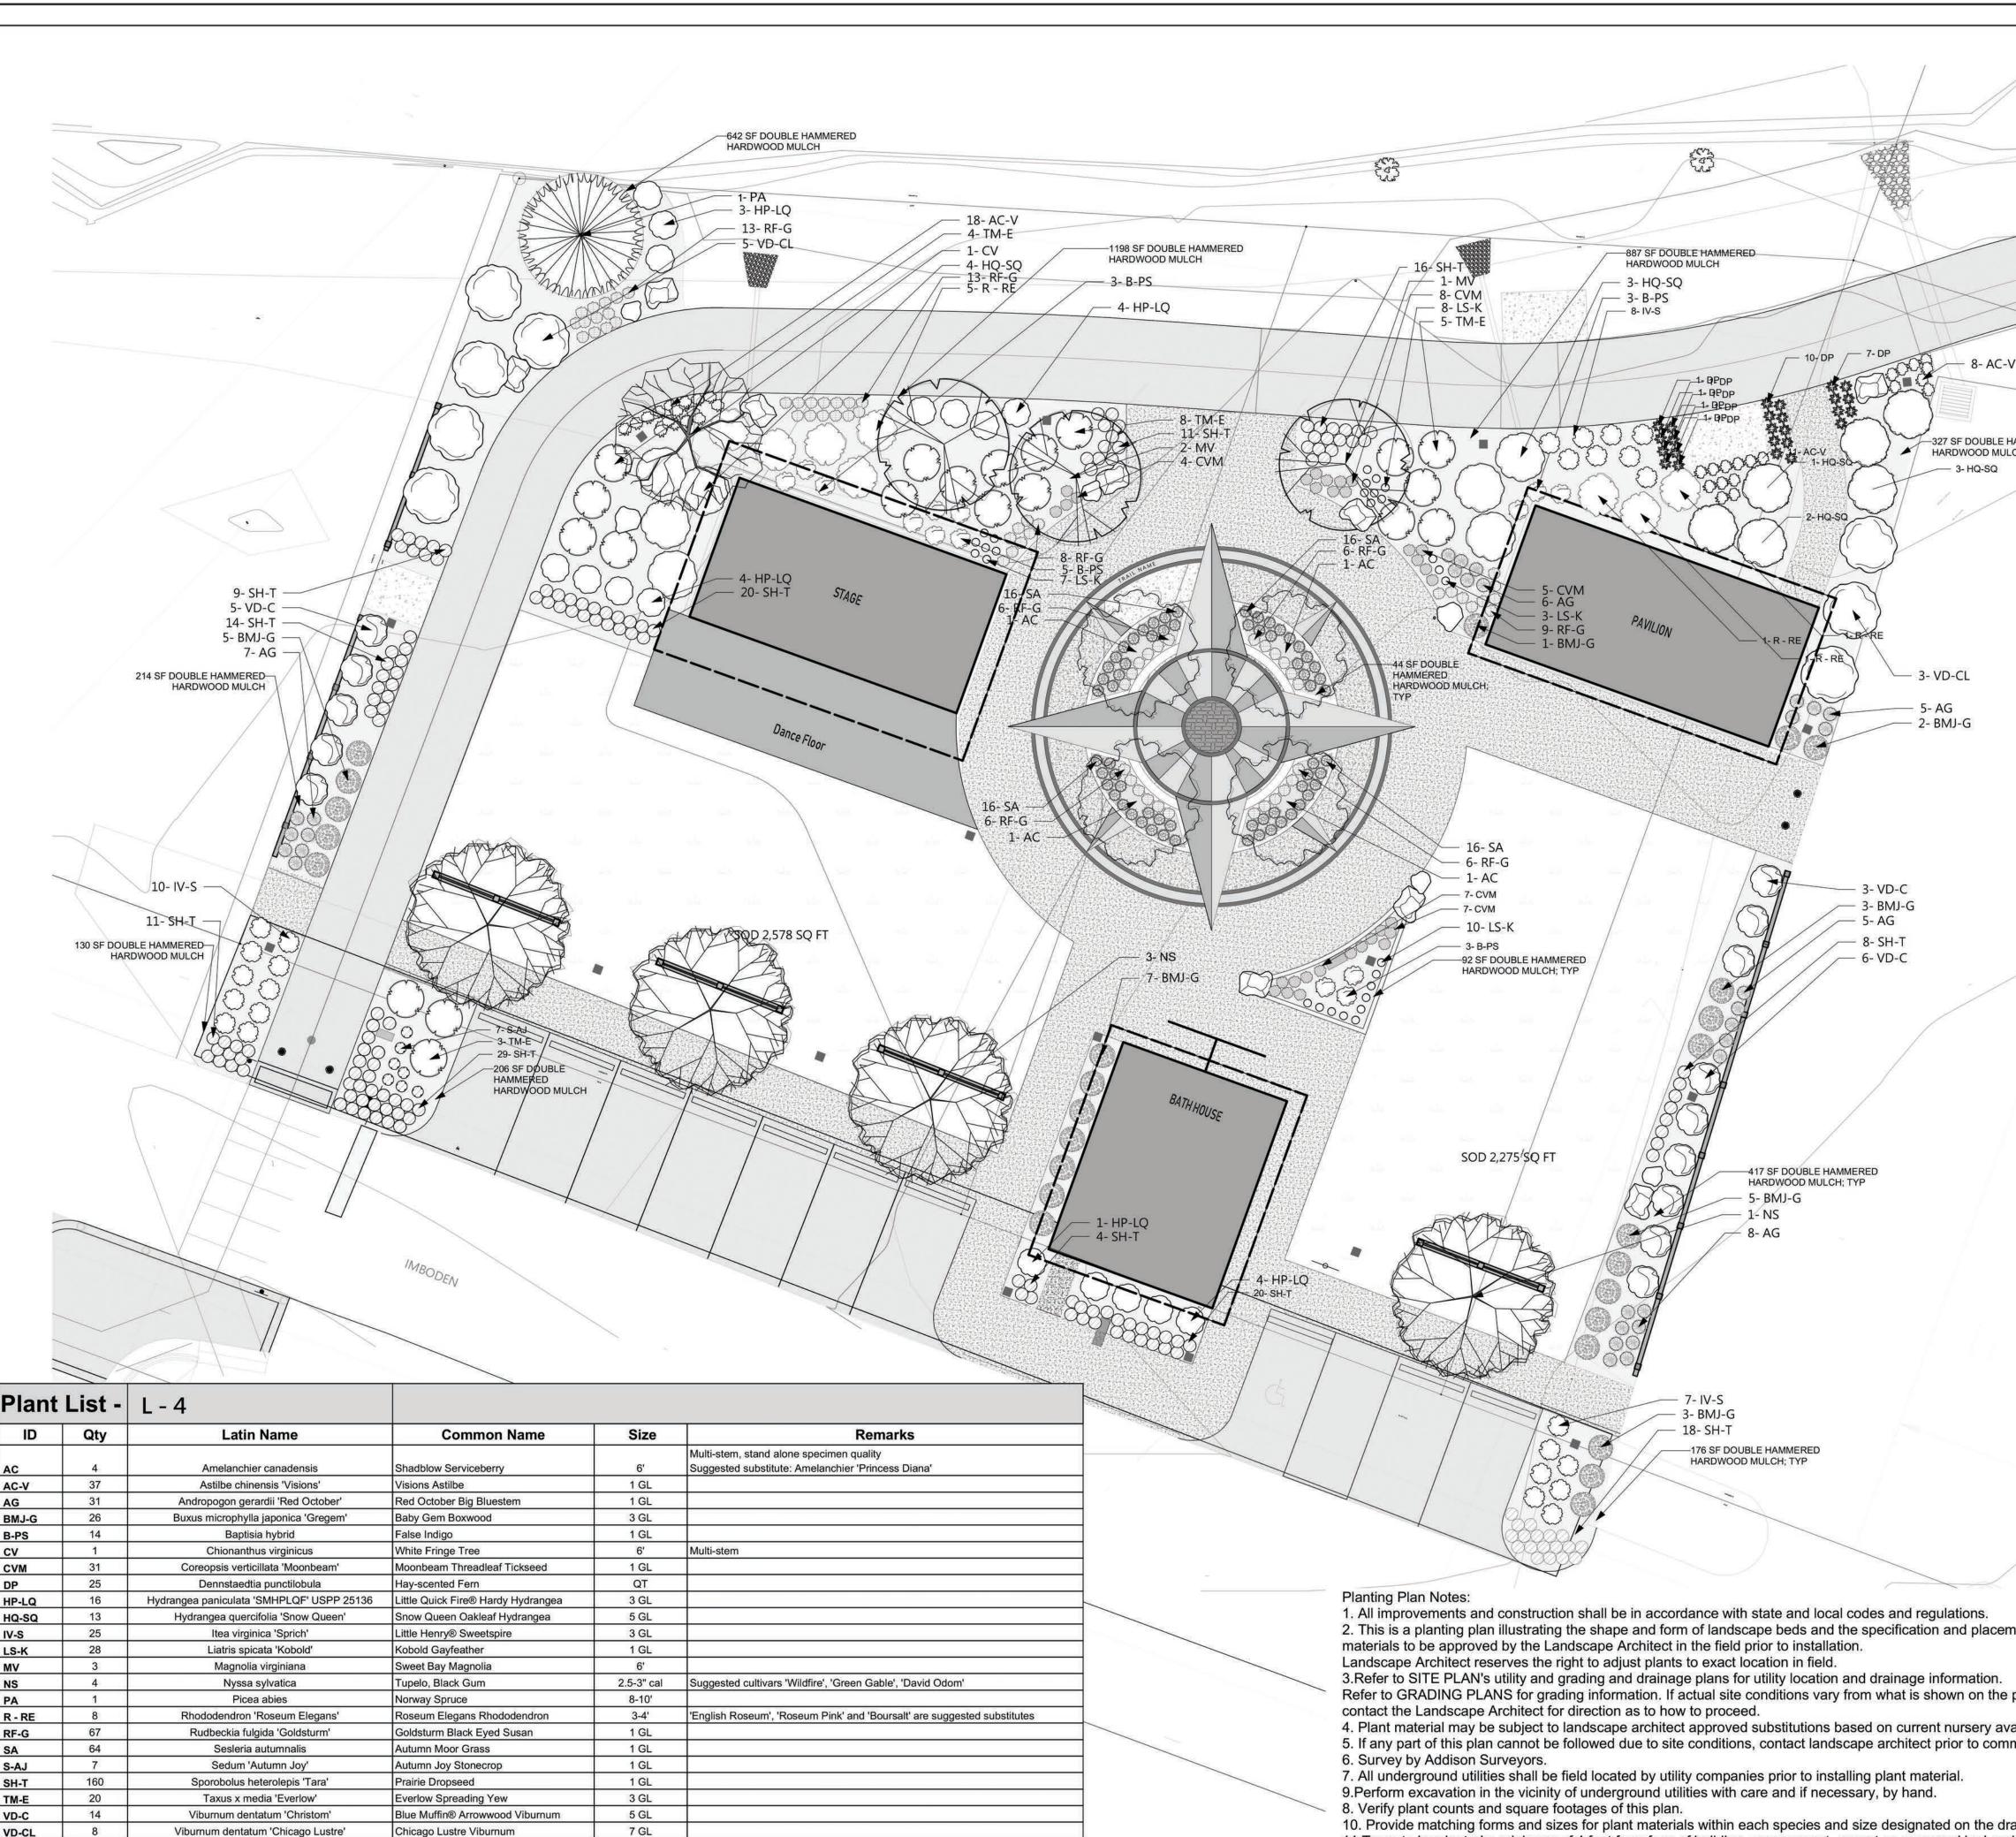

Plant	List -	L - 4			
ID	Qty	Latin Name	Common Name	Size	Remarks
					Multi-stem, stand alone specimen quality
AC	4	Amelanchier canadensis	Shadblow Serviceberry	6'	Suggested substitute: Amelanchier 'Princess Diana'
AC-V	37	Astilbe chinensis 'Visions'	Visions Astilbe	1 GL	
AG	31	Andropogon gerardii 'Red October'	Red October Big Bluestem	1 GL	
BMJ-G	26	Buxus microphylla japonica 'Gregem'	Baby Gem Boxwood	3 GL	
B-PS	14	Baptisia hybrid	False Indigo	1 GL	
cv	1	Chionanthus virginicus	White Fringe Tree	6'	Multi-stem
CVM	31	Coreopsis verticillata 'Moonbeam'	Moonbeam Threadleaf Tickseed	1 GL	
DP	25	Dennstaedtia punctilobula	Hay-scented Fern	QT	
HP-LQ	16	Hydrangea paniculata 'SMHPLQF' USPP 25136	Little Quick Fire® Hardy Hydrangea	3 GL	
HQ-SQ	13	Hydrangea quercifolia 'Snow Queen'	Snow Queen Oakleaf Hydrangea	5 GL	
IV-S	25	Itea virginica 'Sprich'	Little Henry® Sweetspire	3 GL	
LS-K	28	Liatris spicata 'Kobold'	Kobold Gayfeather	1 GL	
MV	3	Magnolia virginiana	Sweet Bay Magnolia	6'	
NS	4	Nyssa sylvatica	Tupelo, Black Gum	2.5-3" cal	Suggested cultivars 'Wildfire', 'Green Gable', 'David Odo
PA	1	Picea abies	Norway Spruce	8-10'	
R - RE	8	Rhododendron 'Roseum Elegans'	Roseum Elegans Rhododendron	3-4'	'English Roseum', 'Roseum Pink' and 'Boursalt' are sugg
RF-G	67	Rudbeckia fulgida 'Goldsturm'	Goldsturm Black Eyed Susan	1 GL	
SA	64	Sesleria autumnalis	Autumn Moor Grass	1 GL	
S-AJ	7	Sedum 'Autumn Joy'	Autumn Joy Stonecrop	1 GL	
SH-T	160	Sporobolus heterolepis 'Tara'	Prairie Dropseed	1 GL	
ТМ-Е	20	Taxus x media 'Everlow'	Everlow Spreading Yew	3 GL	
VD-C	14	Viburnum dentatum 'Christom'	Blue Muffin® Arrowwood Viburnum	5 GL	
VD-CL	8	Viburnum dentatum 'Chicago Lustre'	Chicago Lustre Viburnum	7 GL	

11. Trees to be planted a minimum of 4 feet from face of building, or pavement, except as approved by Land 12. Trees to be planted a minimum of 10 feet from water and sewer lines and a minimum of 15 feet from ele

	PROJECT:
	Laurel Creek
	Park and Trail
	ADDRESS: 208 W Laurel Ave.
E B	Damascus, VA 24236
-V	DEVELOPER:
	DEVELOPER:
HAMMERED	Town of
HAMMERED JLCH	Damascus, VA
	Damascus, VA
	DAMASCUS
	CROSSING PATHS
	Mr. Gavin N. Blevins, Town Manager CONTACT: (276)783-5103, ext. 315
	LANDSCAPE ARCHITECT:
	DESTINATION BY DESIGN
	stutios
	Destination by Design Studios, PLLC
	136 Furman Rd, Ste. 6 Boone, NC 28607
	828-386-1866 www.dbdplanning.com
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	PROJECT MANAGER: CAG
1 LANDSCAPE PLAN L-4	DRAWING BY: DAD JURISDICTION: WASHINGTON COUNTY
Scale: 1" = 10'-0"	JURISDICTION:WASHINGTON COUNTYDATE:11/22/19
ment of plants on the site. Exect leastions of plant	SHEET TITLE:
ment of plants on the site. Exact locations of plant	
e plans or if there are discrepancies between the plans,	LANDSCAPE PLAN
vailability. nmencing work.	SHEET NUMBER:
	SCALE: 1"=10'
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Indiscape Architect. Iectrical and gas lines. Know what's below	FILE NUMBER:
Call before you dig	9.26.16

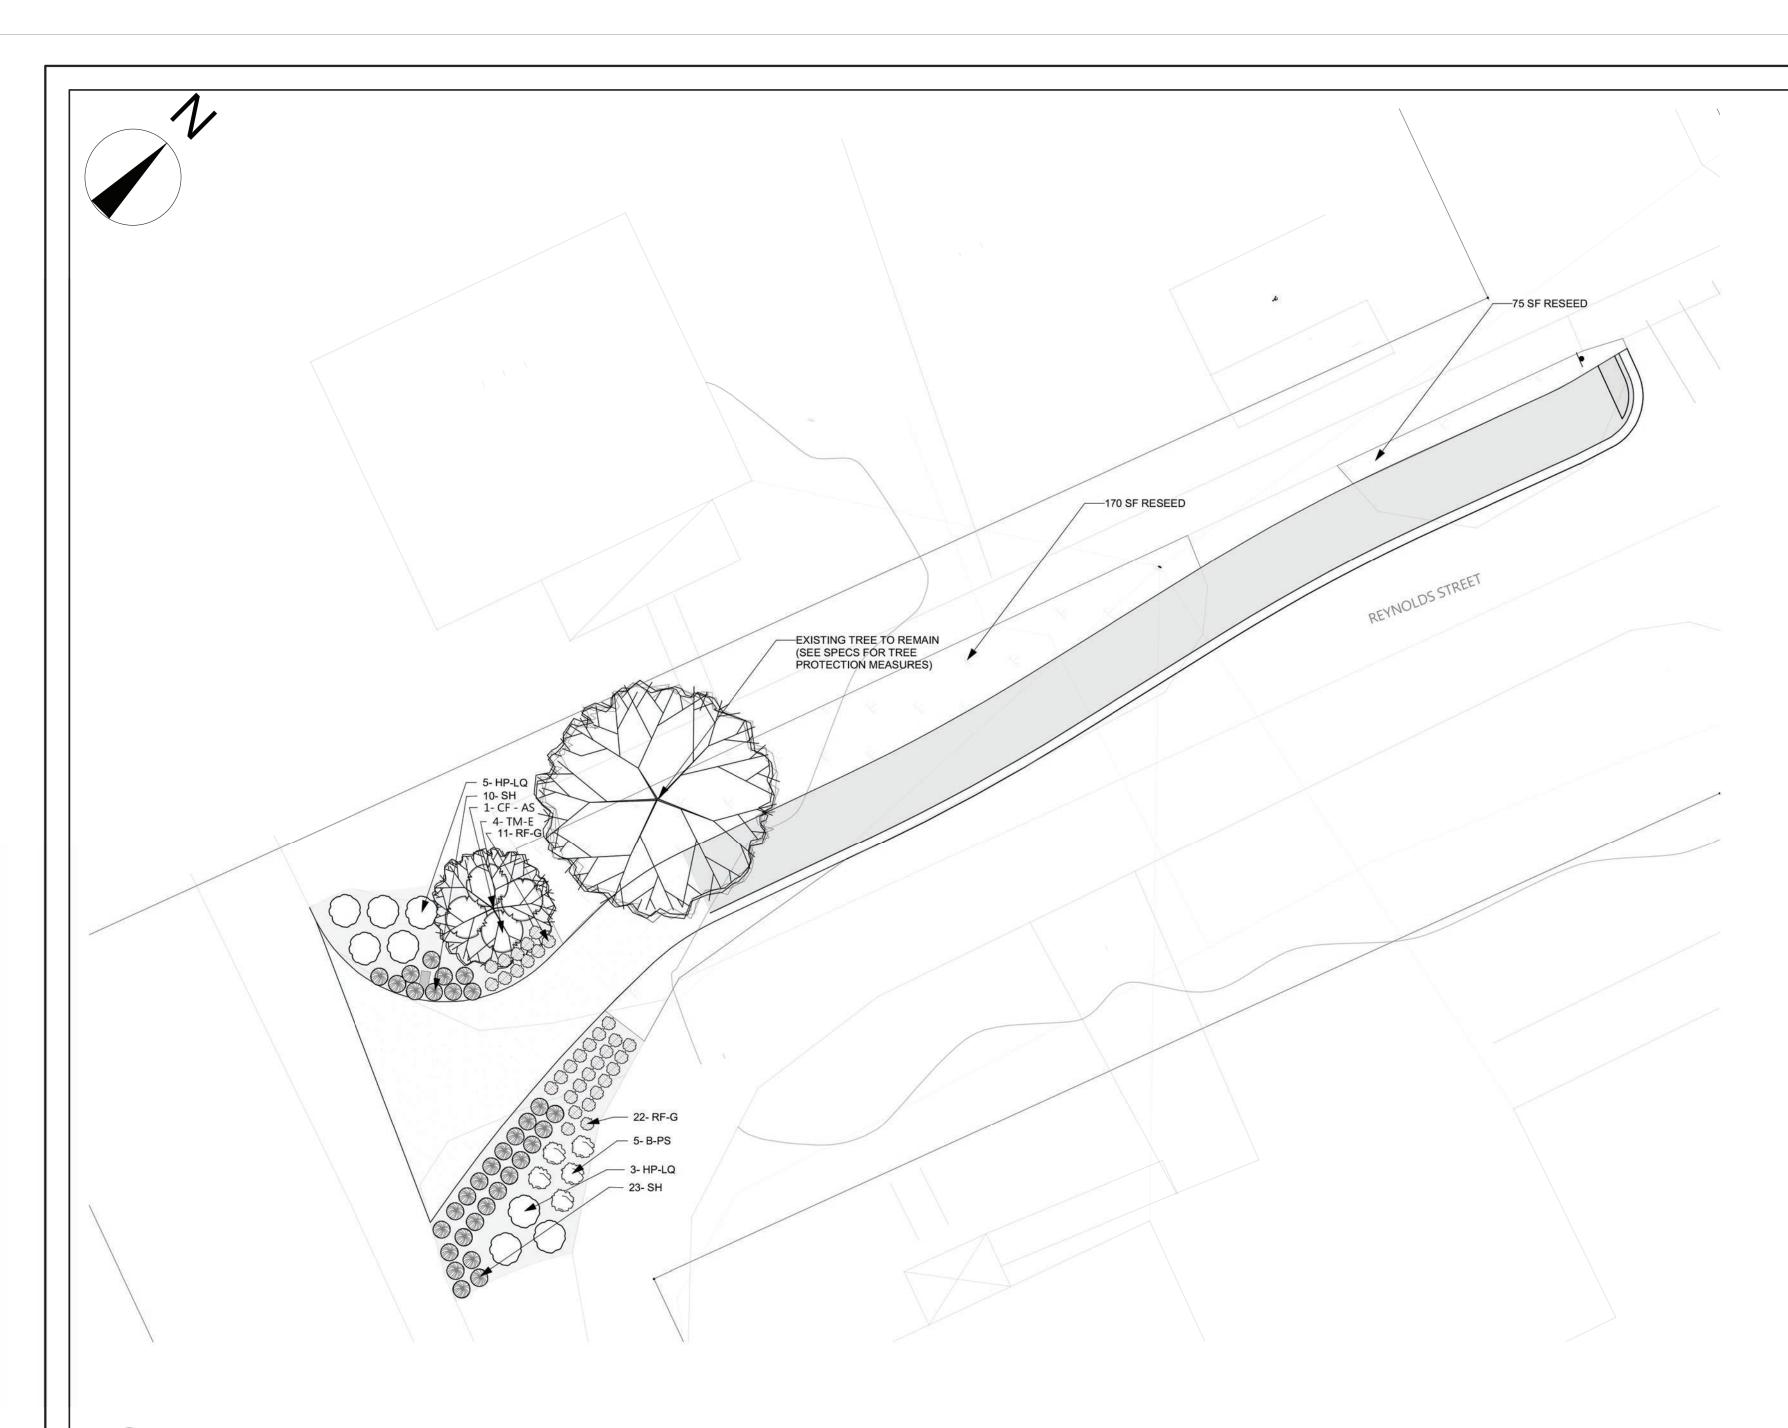

LANDSCAPE PLAN L-5 Scale: 1" = 10'-0"

Plant	List -	L - 5			
ID	Qty	Latin Name	Common Name	Size	Remarks
B-PS	5	Baptisia hybrid	False Indigo	1 GL	
CF - AS	1	Cornus florida 'Appalachian Spring'	Appalachian Spring Dogwood	15 GL/4'	suggested substitute: Cornus "Jean's Appalachian Snow'
HP-LQ	8	Hydrangea paniculata 'SMHPLQF' USPP 25136	Little Quick Fire® Hardy Hydrangea	3 GL	
RF-G	33	Rudbeckia fulgida 'Goldsturm'	Goldsturm Black Eyed Susan	1 GL	
SH	33	Sporobolus heterolepis	Prairie Dropseed	1 GL	
TM-E	4	Taxus x media 'Everlow'	Everlow Spreading Yew	3 GL	

SEED: KENTUCKY BLUE/TALL FESCUE BLEND - 245 SQ FT REFER TO DETAIL 3/SHEET C-2

Planting Plan Notes:

1. All improvements and construction shall be in accordance with state and local codes and regulations.

2. This is a planting plan illustrating the shape and form of landscape beds and the specification and placement of plants on the site. Exact locations of plant materials to be approved by the Landscape Architect in the field prior to installation. Landscape Architect reserves the right to adjust plants to exact location in field.

3.Refer to SITE PLAN's utility and grading and drainage plans for utility location and drainage information.

Refer to GRADING PLANS for grading information. If actual site conditions vary from what is shown on the plans or if there are discrepancies between the plans, contact the Landscape Architect for direction as to how to proceed.

4. Plant material may be subject to landscape architect approved substitutions based on current nursery availability. 5. If any part of this plan cannot be followed due to site conditions, contact landscape architect prior to commencing work.

6. Survey by Addison Surveyors.

7. All underground utilities shall be field located by utility companies prior to installing plant material.


9.Perform excavation in the vicinity of underground utilities with care and if necessary, by hand.

8. Verify plant counts and square footages of this plan.

10. Provide matching forms and sizes for plant materials within each species and size designated on the drawings.


11. Trees to be planted a minimum of 4 feet from face of building, or pavement, except as approved by Landscape Architect.

12. Trees to be planted a minimum of 10 feet from water and sewer lines and a minimum of 15 feet from electrical and gas lines.

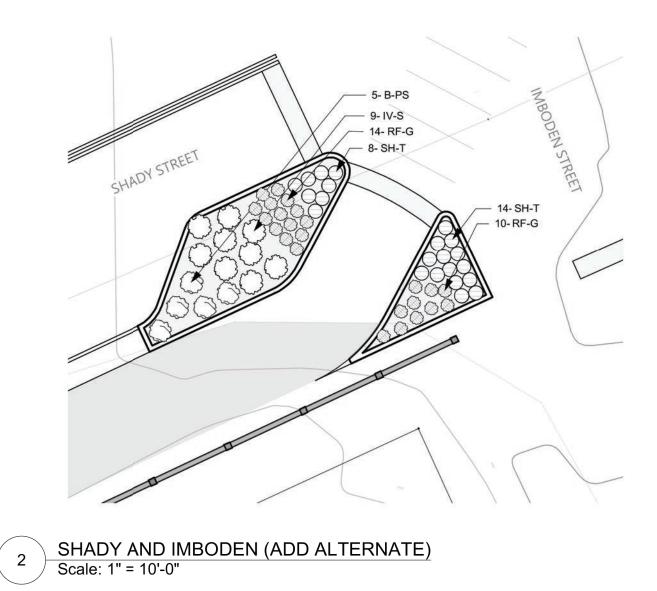

Plant List	L-5_2			
ID	Qty	Latin Name	Common Name	Size
SH-T	22	Sporobolus heterolepis 'Tara'	Prairie Dropseed	1 GL
RF-G	24	Rudbeckia fulgida 'Goldsturm'	Goldstrum Black Eyed Susan	1 GL
IV-S	9	Itea virginica 'Sprich'	Little Henry Sweetspire	3 GL
B-PS	5	Baptisia 'Purple Smoke"	False Indigo	1 GL

*NOT INCLUDED IN MASTER LIST

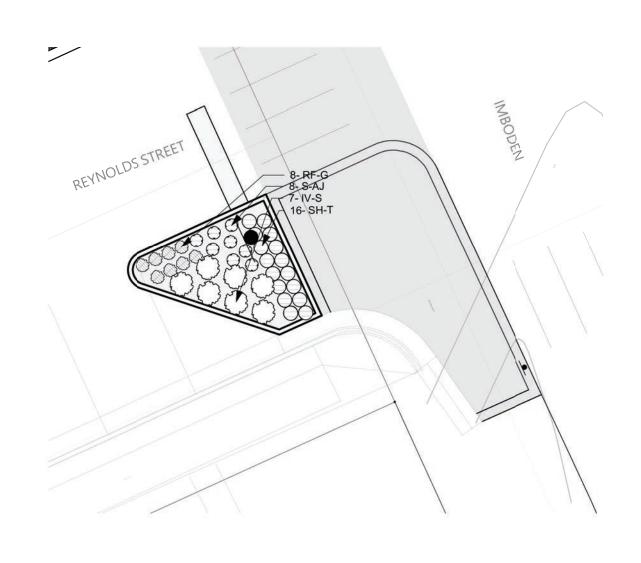



Plant List	L-5_3	
ID	Qty	Latin Name
SH-T	16	Sporobolus heterolepis 'Tara'
RF-G	8	Rudbeckia fulgida 'Goldsturm'
S-AJ	8	Sedum 'Autumn Joy'
IV-S	7	Itea virginica 'Sprich'

*NOT INCLUDED IN MASTER LIST


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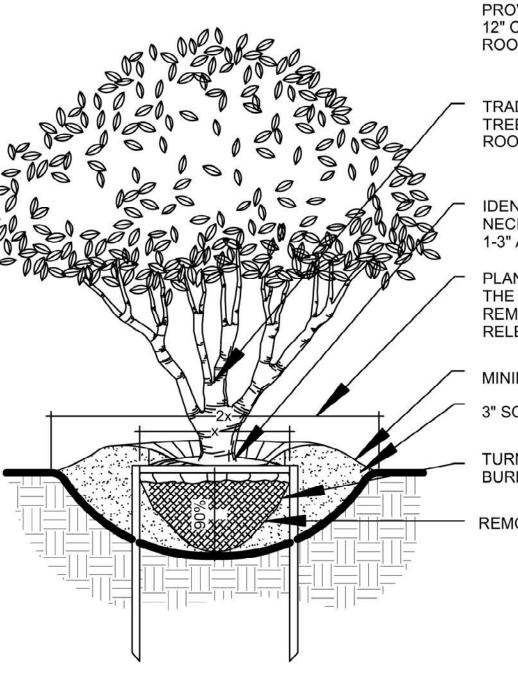
Common Name	Size
Prairie Dropseed	1 GL
Goldstrum Black Eyed Susan	1 GL
Autumn Joy Stonecrop	1 GL
Little Henry Sweetspire	3 GL

Know what's **below**

Call before you dig





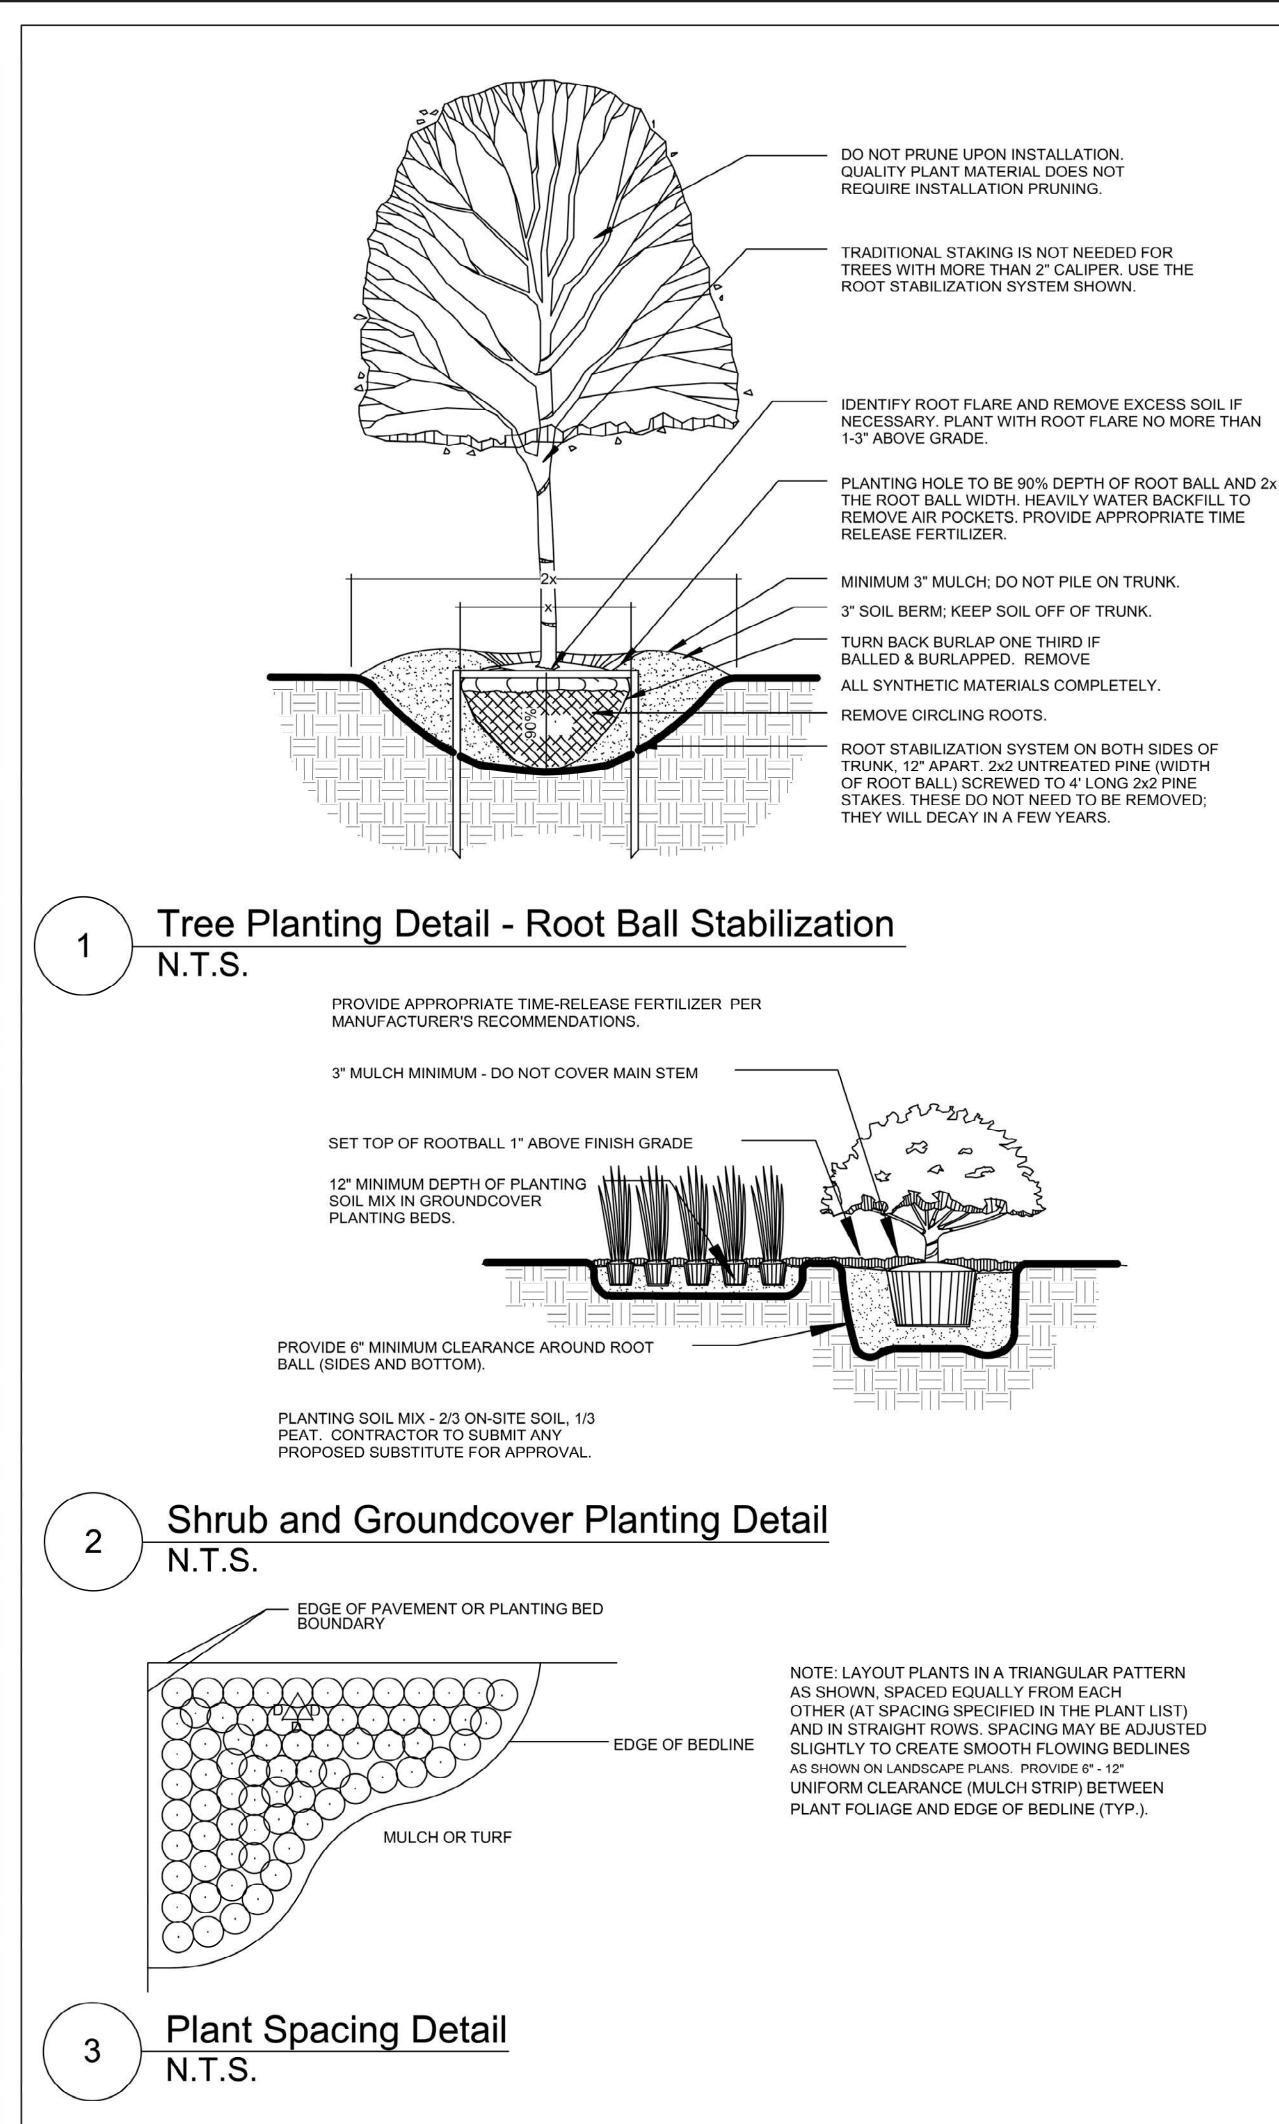

PROVIDE CLEARANCE AROUND ROOT BALL OF 12" ON ALL SIDES AND 6" ON BOTTOM. POSITION ROOT-FLARE 2" ABOVE GRADE.

TRADITIONAL STAKING IS NOT NEEDED FOR TREES WITH MORE THAN 2" CALIPER. USE THE ROOT STABILIZATION SYSTEM SHOWN


IDENTIFY ROOT FLARE AND REMOVE EXCESS SOIL IF NECESSARY. PLANT WITH ROOT FLARE NO MORE THAN 1-3" ABOVE GRADE.

PLANTING HOLE TO BE 90% DEPTH OF ROOT BALL AND 2x THE ROOT BALL WIDTH. HEAVILY WATER BACKFILL TO REMOVE AIR POCKETS. PROVIDE APPROPRIATE TIME RELEASE FERTILIZER.

MINIMUM 3" MULCH - DO NOT COVER MAIN TRUNK 3" SOIL BERM

TURN BACK BURLAP ONE THIRD IF BALLED & BURLAPPED. REMOVE ALL SYNTHETIC MATERIAL.

REMOVE CIRCLING ROOTS.

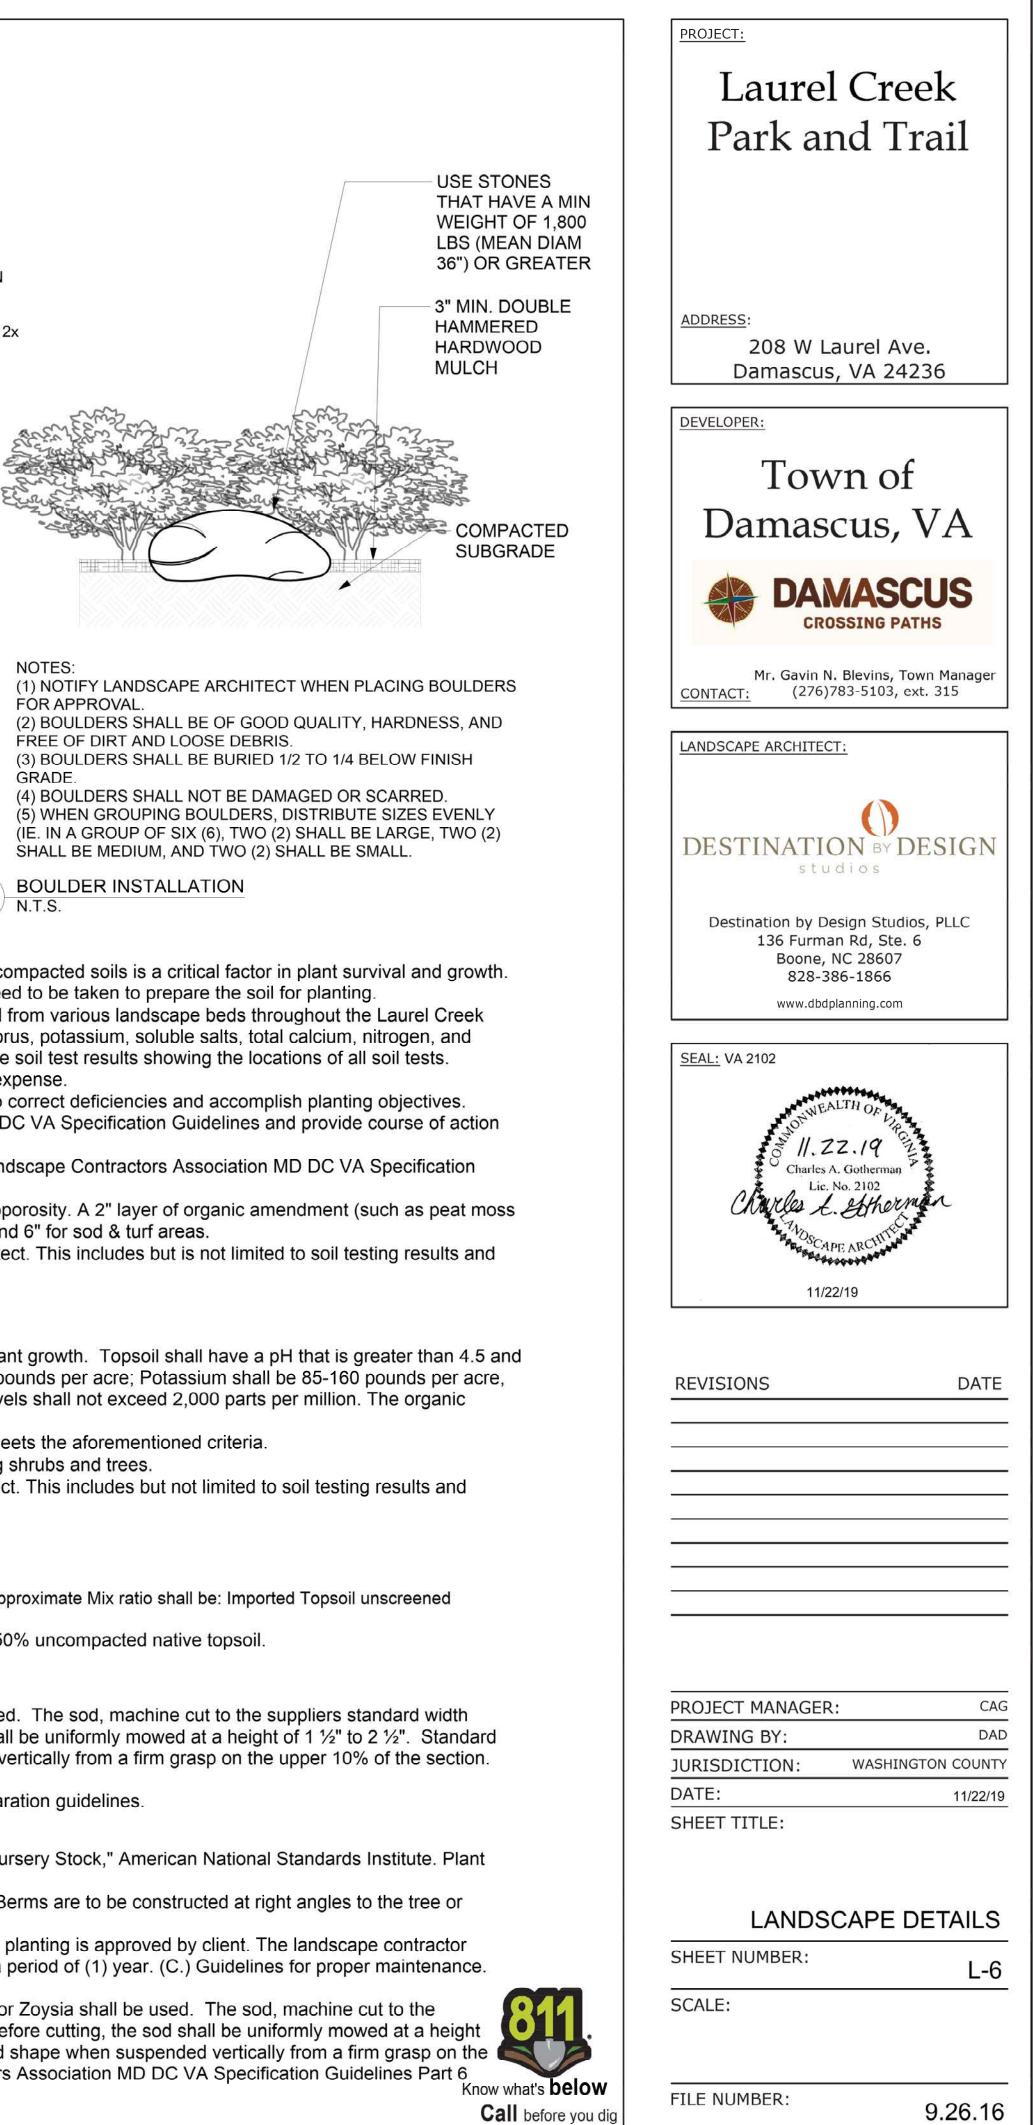

Multi-Trunk Tree Planting Detail 4 N.T.S.

Notes regarding in situ soil:

1. Soil preparation must be conducted by contractor to decompact soils to allow for root growth. Soil preparation of compacted soils is a critical factor in plant survival and growth. The following steps shall be followed to evaluate whether the existing soils on site can be used and the steps that need to be taken to prepare the soil for planting. 2. SOIL TEST: Soils shall be tested at the contractor's expense. A minimum of 3 core 6" soil samples shall be tested from various landscape beds throughout the Laurel Creek Park project area (Sheet L-4). Soil tests shall determine soil texture (mechanical analysis), pH, magnesium, phosphorus, potassium, soluble salts, total calcium, nitrogen, and percent organic matter. If the soil is sandy, it shall also be tested for boron. The Contractor shall submit plans with the soil test results showing the locations of all soil tests. Incomplete test results and plans will be rejected by Destination by Design, and shall be redone at the Contractor's expense. 4. AMEND BASED ON TESTING: Soil test results shall include laboratory recommendations for soil amendments to correct deficiencies and accomplish planting objectives. Follow recommendations of laboratory and/or Soil Part 7 section 3.2 of the Landscape Contractors Association MD DC VA Specification Guidelines and provide course of action based on their recommendation.

5. SUBSOILING: For all planting beds that had previously been roads or covered in asphalt/concrete refer to the Landscape Contractors Association MD DC VA Specification Guidelines Part 7(Soils) section 3.4 for directions on subsoiling with equipment to reduce compaction.

6. AMEND FOR COMPACTION: Amended with organic matter to make a positive change in bulk density and macroporosity. A 2" layer of organic amendment (such as peat moss or composted/aged pine bark fines) shall be tilled or dug to a minimum depth of 18" throughout all landscape beds and 6" for sod & turf areas. 7. **REPORT:** Commencement of work will not begin until all submittals have been approved by the Landscape Architect. This includes but is not limited to soil testing results and recommendations.

Notes regarding imported topsoil:

1. If the exiting soils can not be used then imported topsoil must meet the following criteria listed below.

2. APPROVAL: Imported topsoil shall be free of stones 1 inch or larger and other extraneous materials harmful to plant growth. Topsoil shall have a pH that is greater than 4.5 and less than 7.5. The acceptable amount of Magnesium shall be 71-124 pounds per acre; Phosphorus shall be 62-102 pounds per acre; Potassium shall be 85-160 pounds per acre, and Nitrogen shall be a minimum of 50 pounds per acre. The soluble salts shall not exceed 4mmhos/cm, Calcium levels shall not exceed 2,000 parts per million. The organic matter shall exceed 5%. It shall not be added to beds or planted when it is frozen or muddy to avoid compaction.

3. SOIL TEST: Soil tests shall determine proposed topsoil texture (mechanical analysis) and that proposed topsoil meets the aforementioned criteria. 4. DEPTH: Topsoil will be installed to a depth of 12" for perennial/ornamental grass beds and 18" for beds containing shrubs and trees. 5. REPORT: Commencement of work will not begin until all submittals have been approved by the landscape architect. This includes but not limited to soil testing results and recommendations.

Notes regarding tree wells:

1. Tree wells shall be 30" deep. Install plant mix and subsoil plant mix in lifts, compacting lightly inbetween.

2. PLANT MIX: The top 12" of tree wells shall be a mixture a Mix of Imported Topsoil, Coarse Sand and Compost. The approximate Mix ratio shall be: Imported Topsoil unscreened

(45-50%) Coarse sand (40-45%) Compost (10%) 3. SUBSOIL PLANT MIX: Tree well subsoil shall be 18" in depth and consist of 50% aforementioned plant mix and 50% uncompacted native topsoil.

Notes regarding sod:

1.Only "approved sod" (trade designation) consisting of a mixture of Kentucky Bluegrass and Tall Fescue shall be used. The sod, machine cut to the suppliers standard width and length, shall be 5/8" minimum, excluding top growth and thatch, at the time of cutting. Before cutting, the sod shall be uniformly mowed at a height of 1 1/2" to 2 1/2". Standard sod sections shall be sufficiently strong to support their own weight and retain their size and shape when suspended vertically from a firm grasp on the upper 10% of the section. The sod may be either 42" wide roll sod or 18" by 36" strips.

2. Refer to the Landscape Contractors Association MD DC VA Specification Guidelines Part 6 Section 3 for soil preparation guidelines.

General Notes:

1. Plant material shall conform to the standards for Grade #1 or better as given in the latest "American Standard for Nursery Stock," American National Standards Institute. Plant size is to take precedence over container size.

2. All trees and shrubs are to be positioned vertically regardless of the slope of the ground in which they are planted. Berms are to be constructed at right angles to the tree or shrub or in a manner in which they will most effectively serve the purpose of retaining water at the base of the plant.

3. Landscape material is to be maintained by the landscape contractor (including mowing, pruning, and weeding) until planting is approved by client. The landscape contractor must provide: (A.) A warranty on all trees for a period of (1) year. (B.) A warranty on all shrubs and groundcovers for a period of (1) year. (C.) Guidelines for proper maintenance. 4. Mulch all planting beds with 3" of double ground hardwood mulch.

5.Only "approved sod" (trade designation) consisting of a mixture of 50% Kentucky Bluegrass and 50% Hard Fescue or Zoysia shall be used. The sod, machine cut to the suppliers standard width and length, shall be 5/8" minimum, excluding top growth and thatch, at the time of cutting. Before cutting, the sod shall be uniformly mowed at a height of 1 1/2" to 2 1/2". Standard sod sections shall be sufficiently strong to support their own weight and retain their size and shape when suspended vertically from a firm grasp on the upper 10% of the section. The sod may be either 42" wide roll sod or 18" by 36" strips. Refer to Landscape Contractors Association MD DC VA Specification Guidelines Part 6 (Seeding and Sodding) specifications for soil preparation specifications for sod areas.

All disturbed areas not otherwise planted shall be stabilized with a blend of Kentucky Blue/ Hard Fescue grass.